



TYPICAL HOUSE SOIL EROSION CONTROL PLAN
NOT TO SCALE

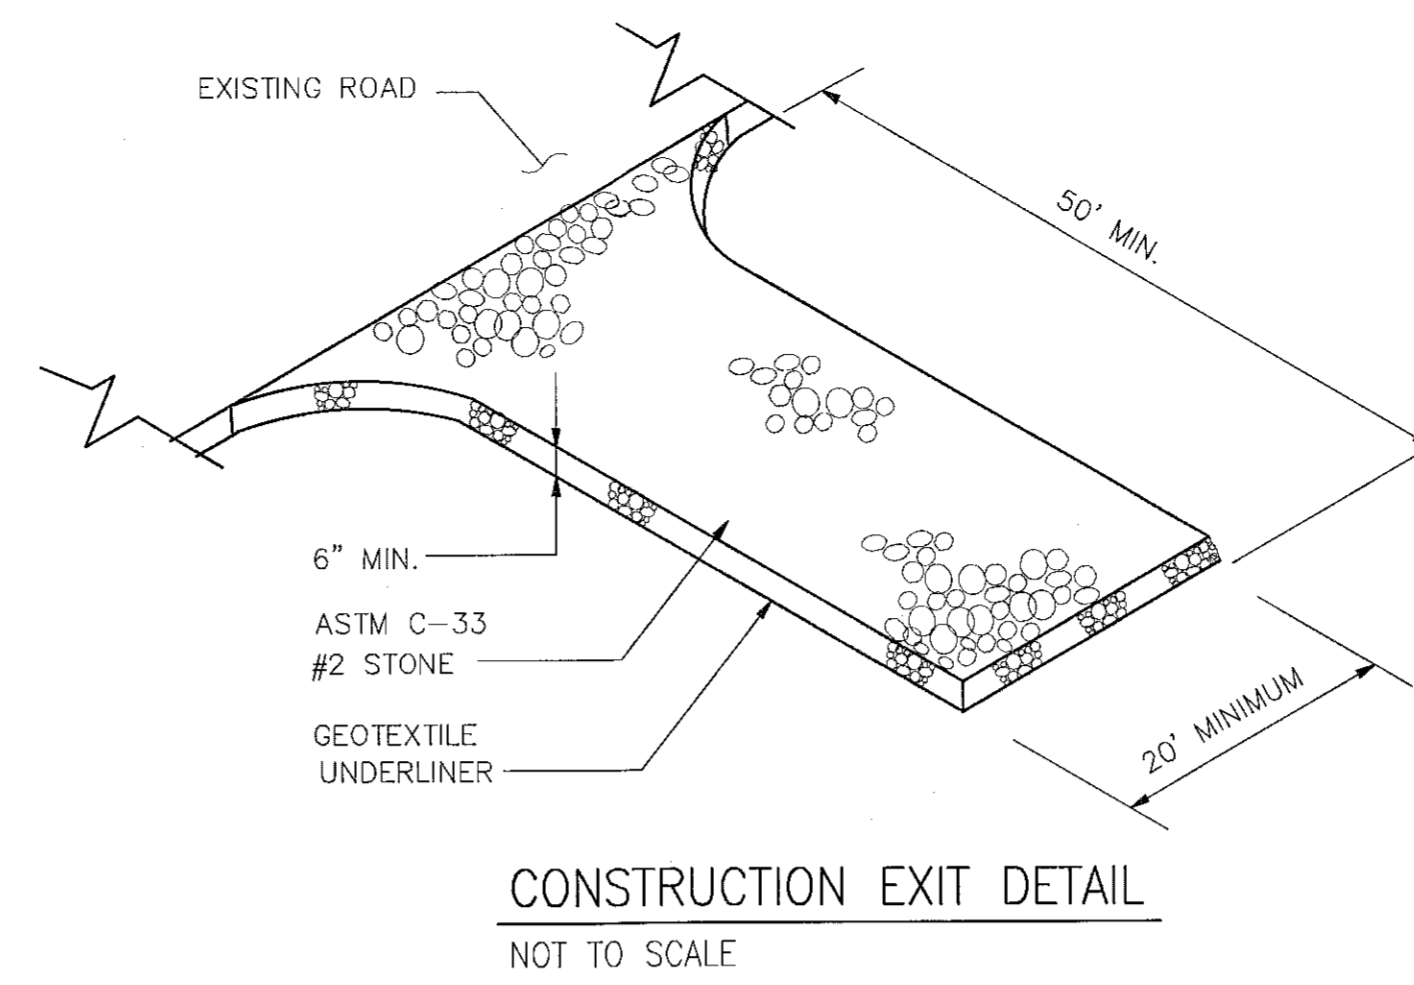


CONSTRUCTION EXIT DETAIL
NOT TO SCALE

EROSION CONTROL BLANKET
PLACEMENT DETAIL
NOT TO SCALE


- NOTES:
1. GEOTEXTILE SHALL BE CUT FROM A CONTINUOUS ROLL TO ELIMINATE JOINTS. IF ANY JOINTS ARE NECESSARY THEY WILL BE OVERLAPPED TO THE NEXT STAKE.
 2. STAKE MATERIAL WILL BE STANDARD 2"x4" WOOD OR EQUIVALENT METAL WITH A MINIMUM LENGTH OF 3 FEET.
 3. SPACE STAKES EVENLY AROUND INLET WITH A MAXIMUM SPACING OF 3 FEET. DRIVE STAKES 18" MINIMUM INTO GROUND. WIRE MESH MAY BE REQUIRED BEHIND GEOTEXTILE TO PROVIDE SUPPORT.
 4. GEOTEXTILE SHALL BE EMBEDDED 12" BELOW GROUND AND BACKFILLED. IT SHALL BE SECURELY FASTENED TO STAKES AND FRAME.
 5. A 2"x4" WOOD FRAME SHALL BE FORMED AROUND THE CREST OF FABRIC FOR OVERFLOW STABILITY.
 6. INLET PROTECTION TO REMAIN IN-PLACE UNTIL AREA IS STABILIZED.

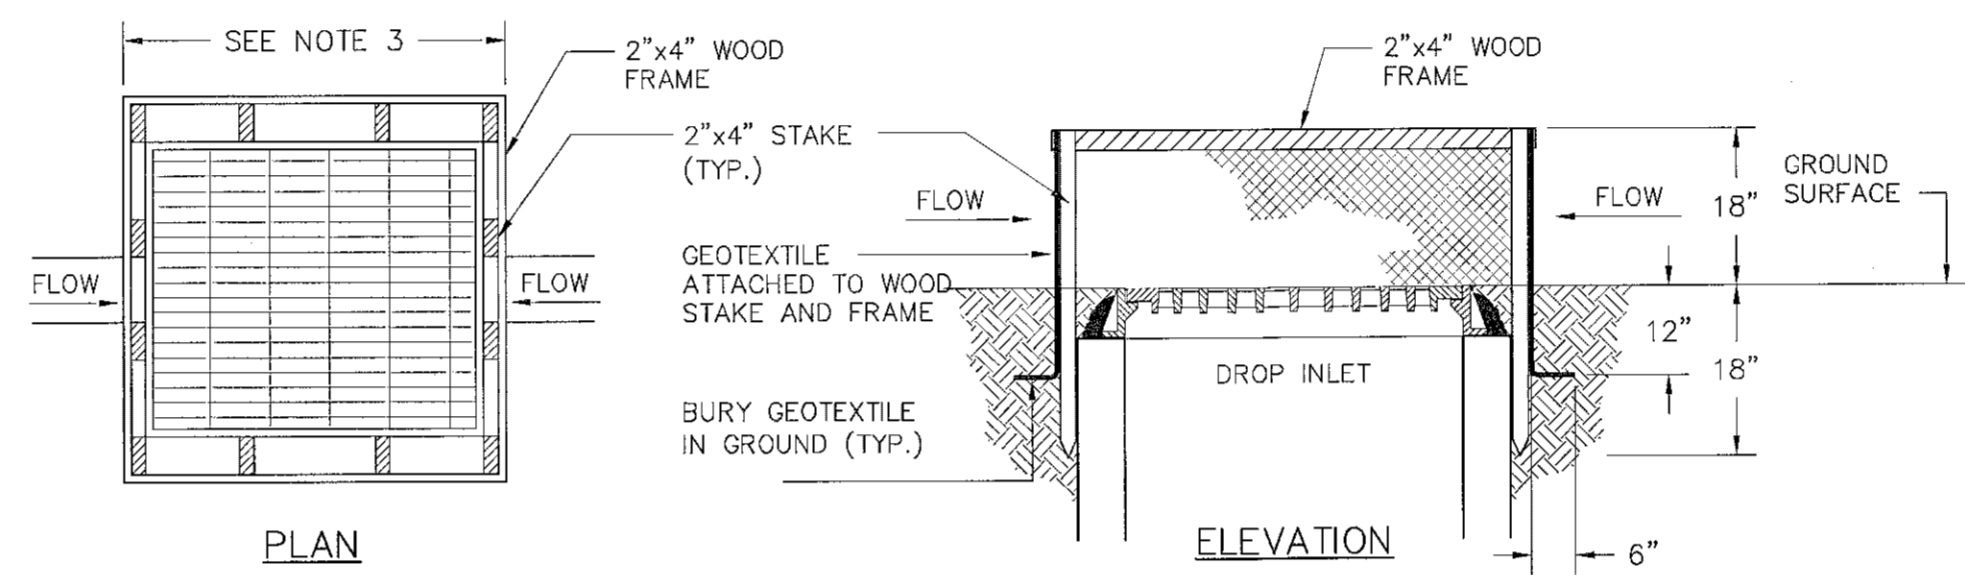

CATCH BASIN INLET PROTECTION (NO PAVEMENT)
NOT TO SCALE


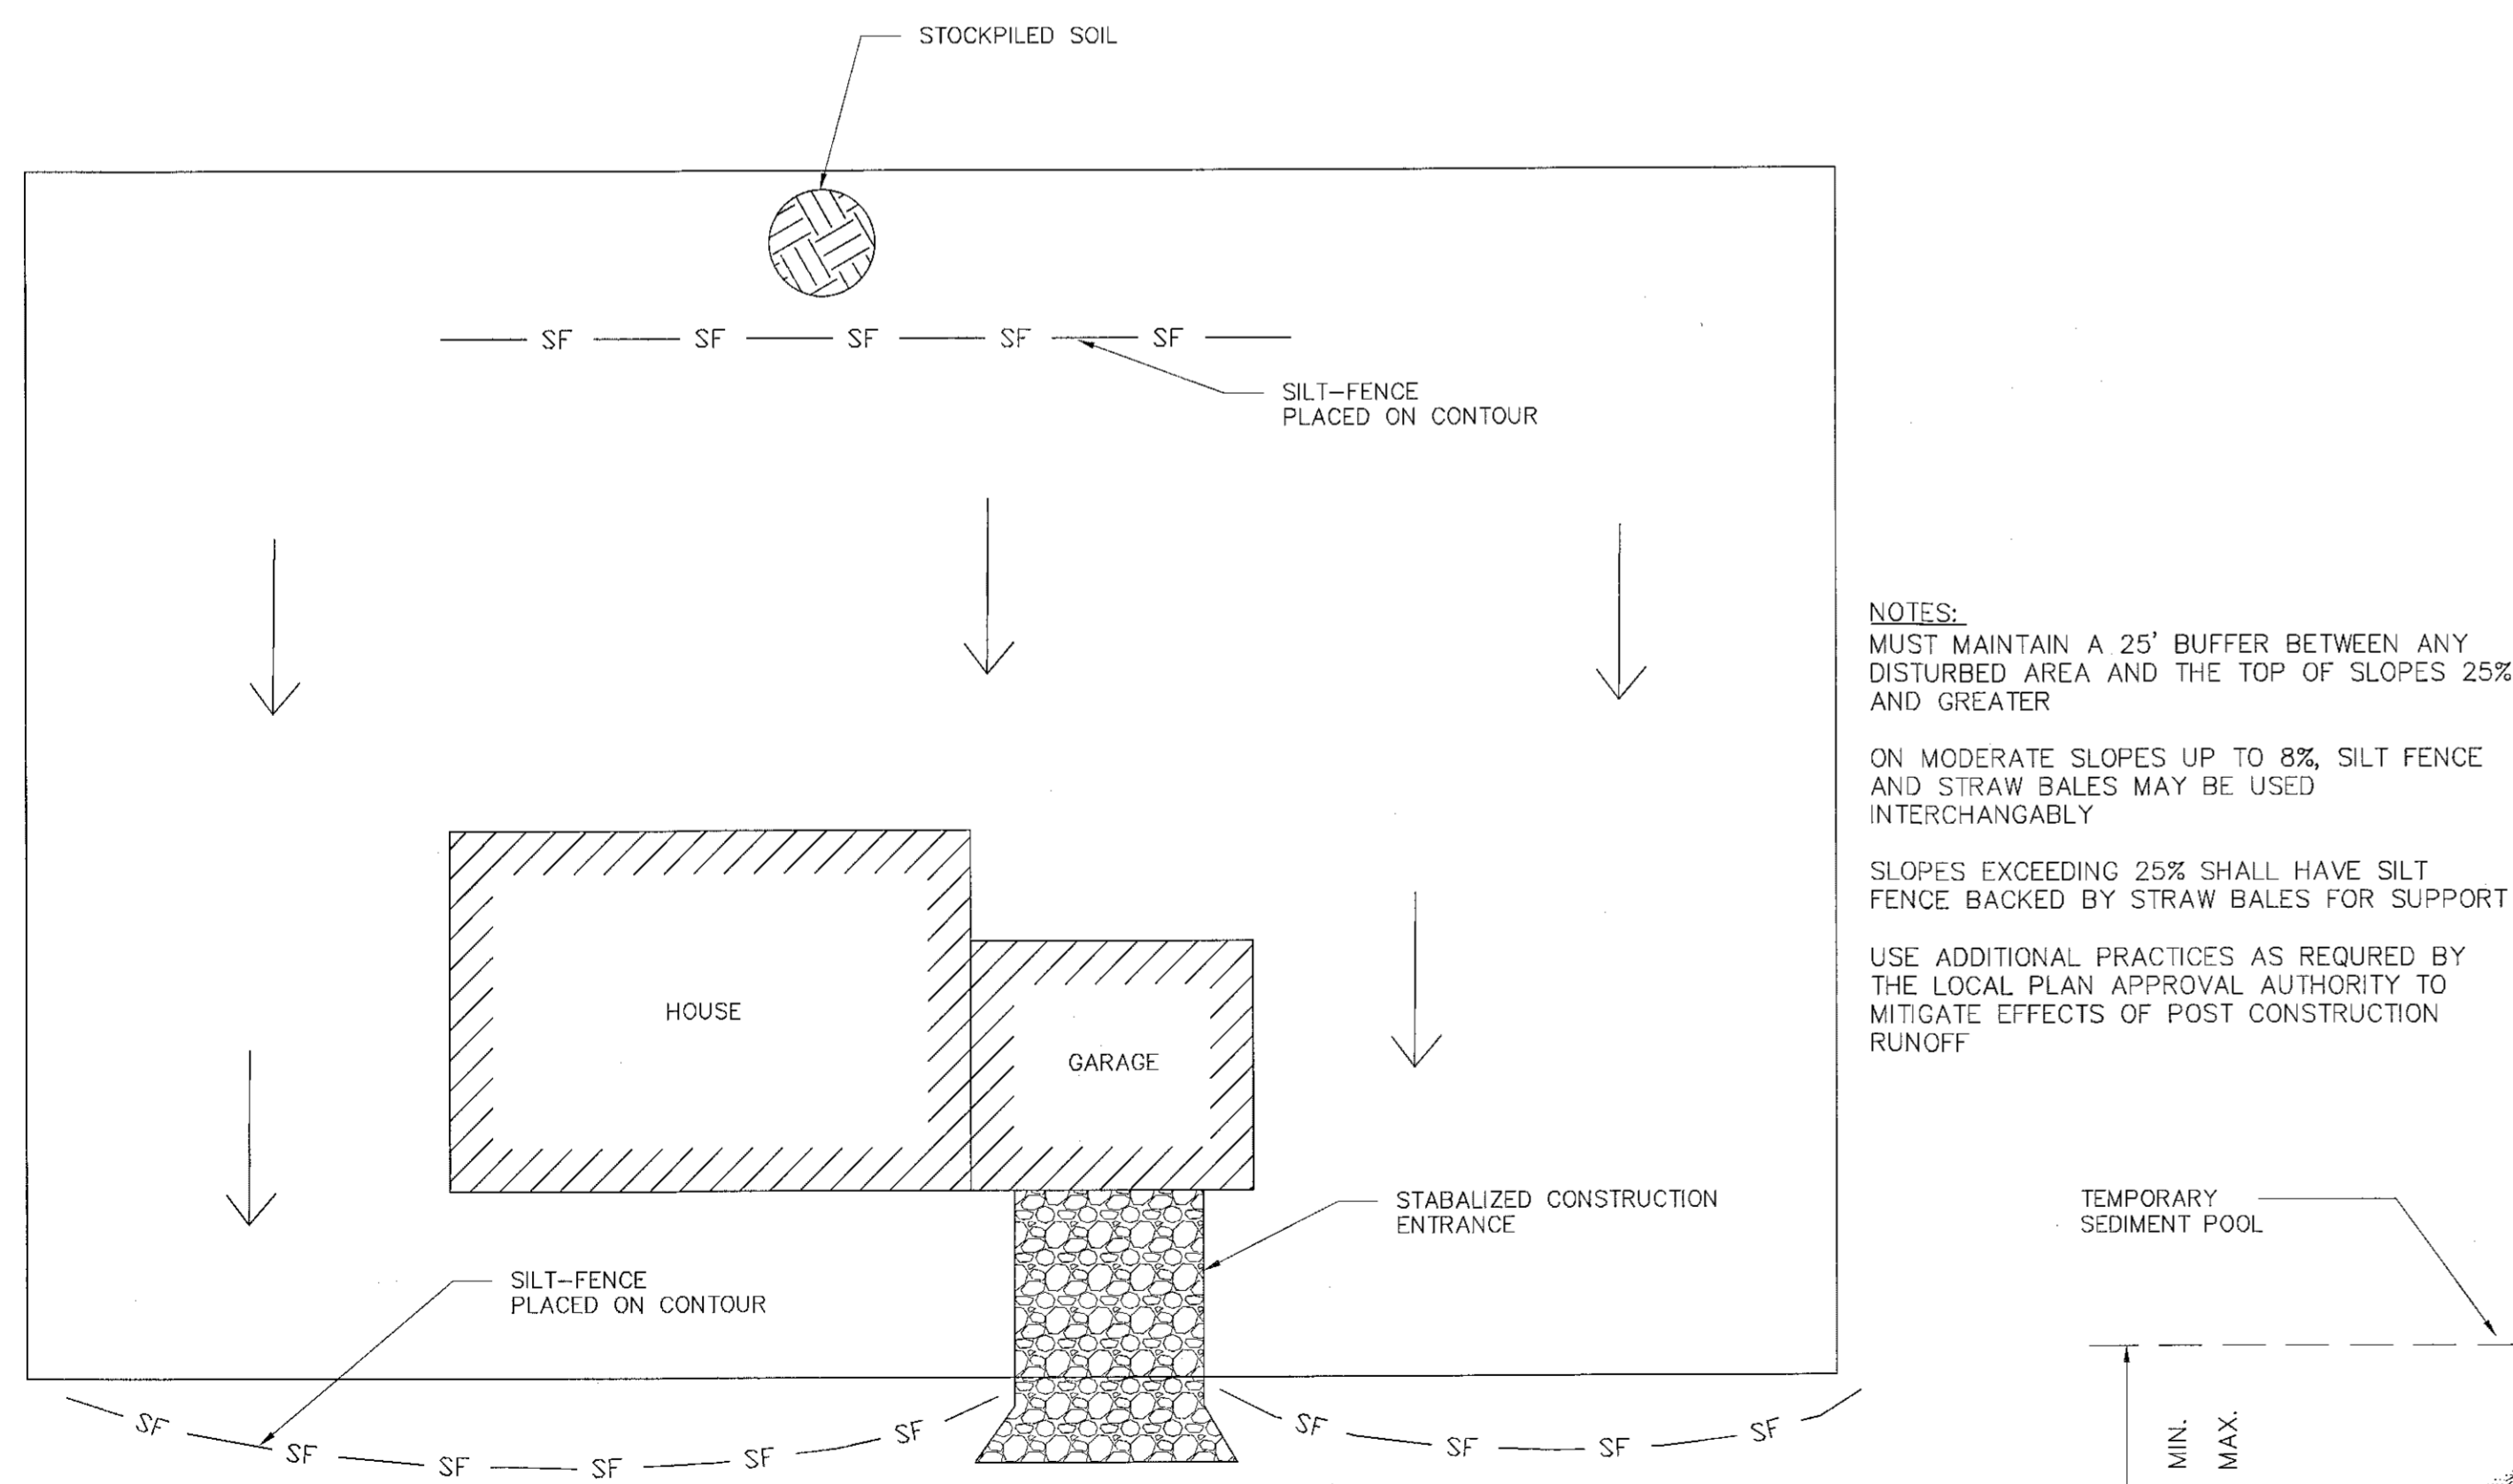


TYPICAL HOUSE SOIL EROSION CONTROL PLAN
NOT TO SCALE

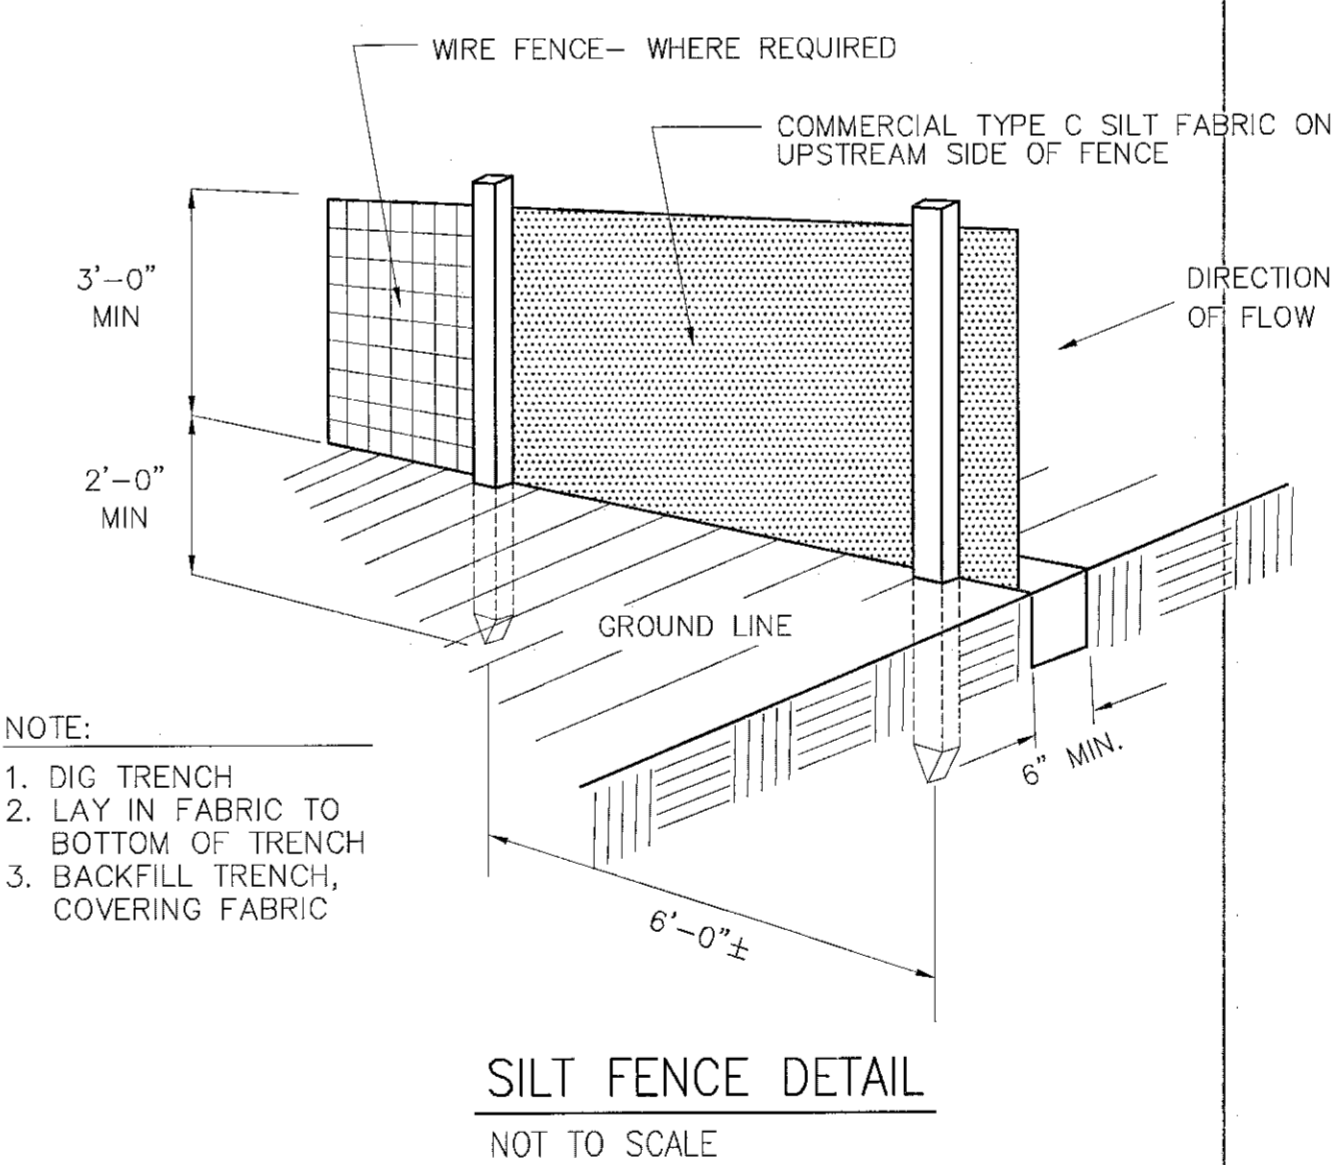

SILT FENCE DETAIL
NOT TO SCALE

- CONSTRUCTION NOTES FOR FABRICATED SILT FENCE
1. WOVEN WIRE FENCE TO BE FASTENED SECURELY TO FENCE POSTS WITH WIRE TIES OR STAPLES. POSTS: STEEL EITHER T OR U TYPE.
 2. FILTER CLOTH TO BE FASTENED SECURELY TO WOVEN WIRE FENCE WITH TIES SPACED EVERY 24" AT TOP AND MID SECTION. FENCE: WOVEN WIRE, 14 GA. 6" MAX. MESH OPENING.
 3. WHEN TWO SECTIONS OF FILTER CLOTH ADJOIN EACH OTHER THEY SHALL BE OVERLAPPED BY SIX INCHES AND FOLDED. FILTER CLOTH: FILTER X, MIRAFI 100X STABILINKA T140N OR APPROVED EQUAL.
 4. MAINTENANCE SHALL BE PERFORMED AS NEEDED AND MATERIAL REMOVED WHEN "BUDGES" DEVELOP IN THE SILT FENCE. PREFABRICATED UNIT: GEOFAB, ENVIROFENCE OR APPROVED EQUAL.
 5. ALL SILT FENCE MATERIALS MUST BE LISTED ON THE CURRENT STATES, D.O.T. QUALIFIED PRODUCTS LIST.

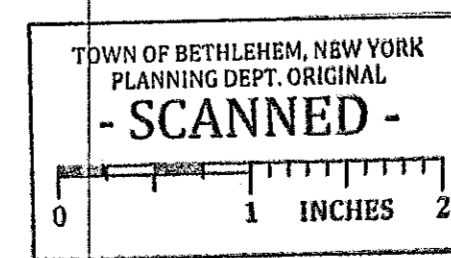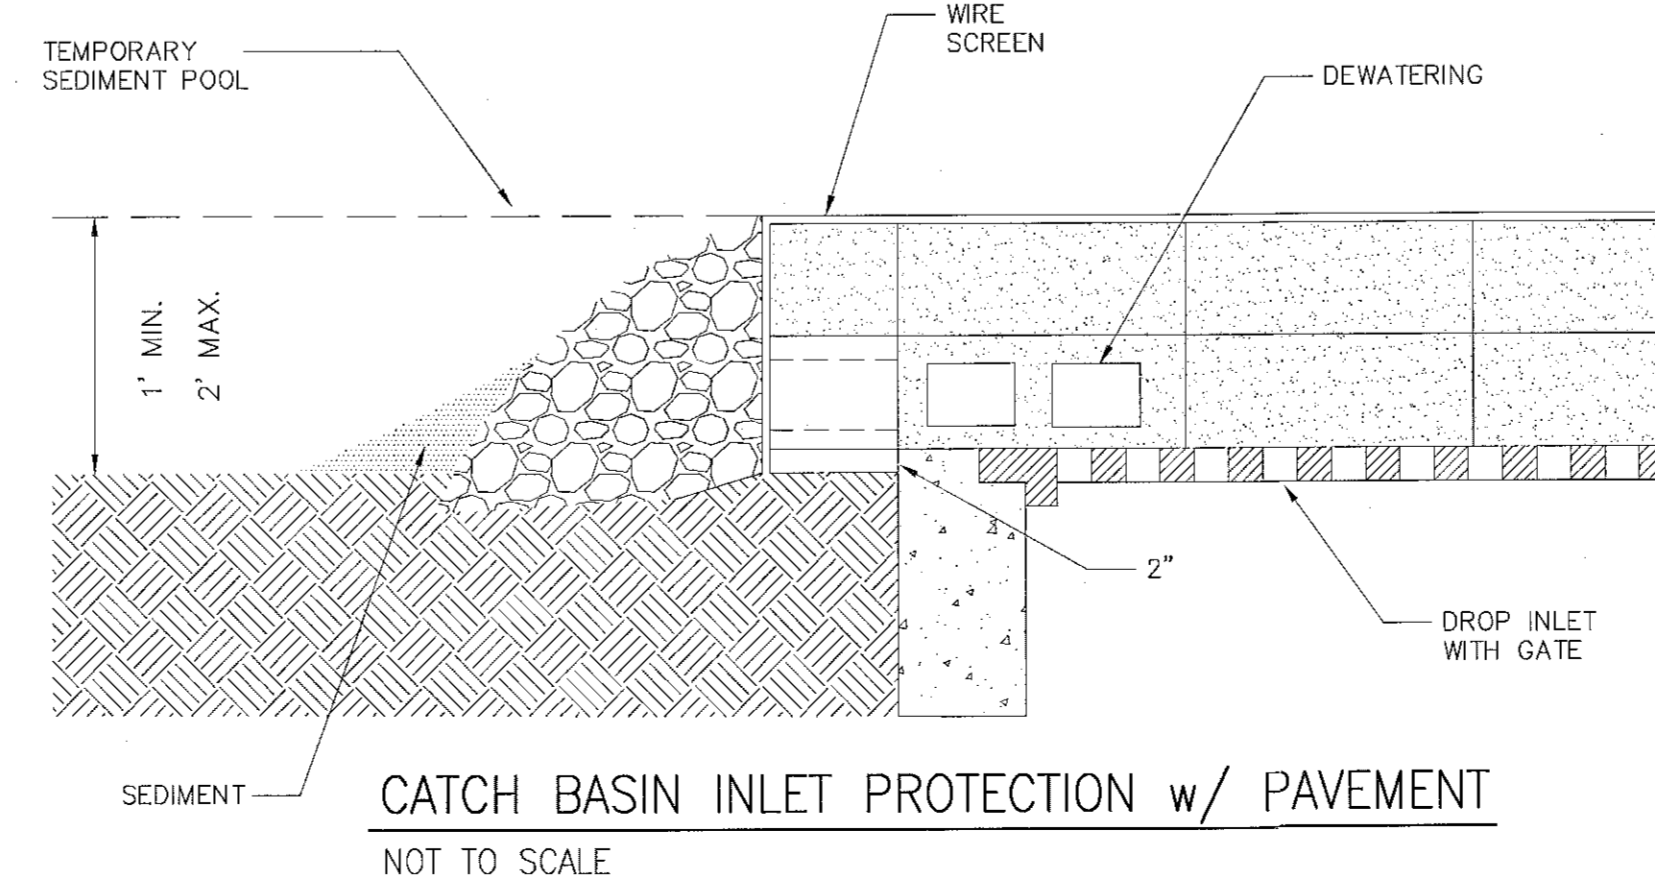

TOWN OF BETHLEHEM APPROVAL

Town of Bethlehem Planning Board
By direction of the Chairman
these plans are hereby Approved.
See 5/1 sheet for date & signature.

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|----------|-----|----------|
| 11/07/11 | MBT | BY |
| 06/02/11 | MBT | DATE |
| 03/08/11 | MBT | REVISION |
| 01/21/11 | MBT | NO. |
| 12/01/10 | MBT | |
| 09/30/10 | MBT | |
| 05/14/10 | MBT | |
| 02/10/09 | MBT | |

FINAL SUBDIVISION PLANS

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PROFESSIONAL ENGINEER
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DESIGNED: M.B.T. | DRAWN BY: T.A.R. | CHECKED: M.B.T.

THE PINES AT NORMANSIDE
LEONARD PLACE
TOWN OF BETHLEHEM, NEW YORK

SOIL & EROSION CONTROL DETAILS

DATE: 11-07-2011 | CME No.: 08-000 | SCALE: AS NOTED

C 12
SHEET NUMBER 12 of 13