



SHRUBS SHALL BEAR SAME RELATION TO FINISHED GRADE AS THEY BORE TO PREVIOUS EXISTING GRADE.

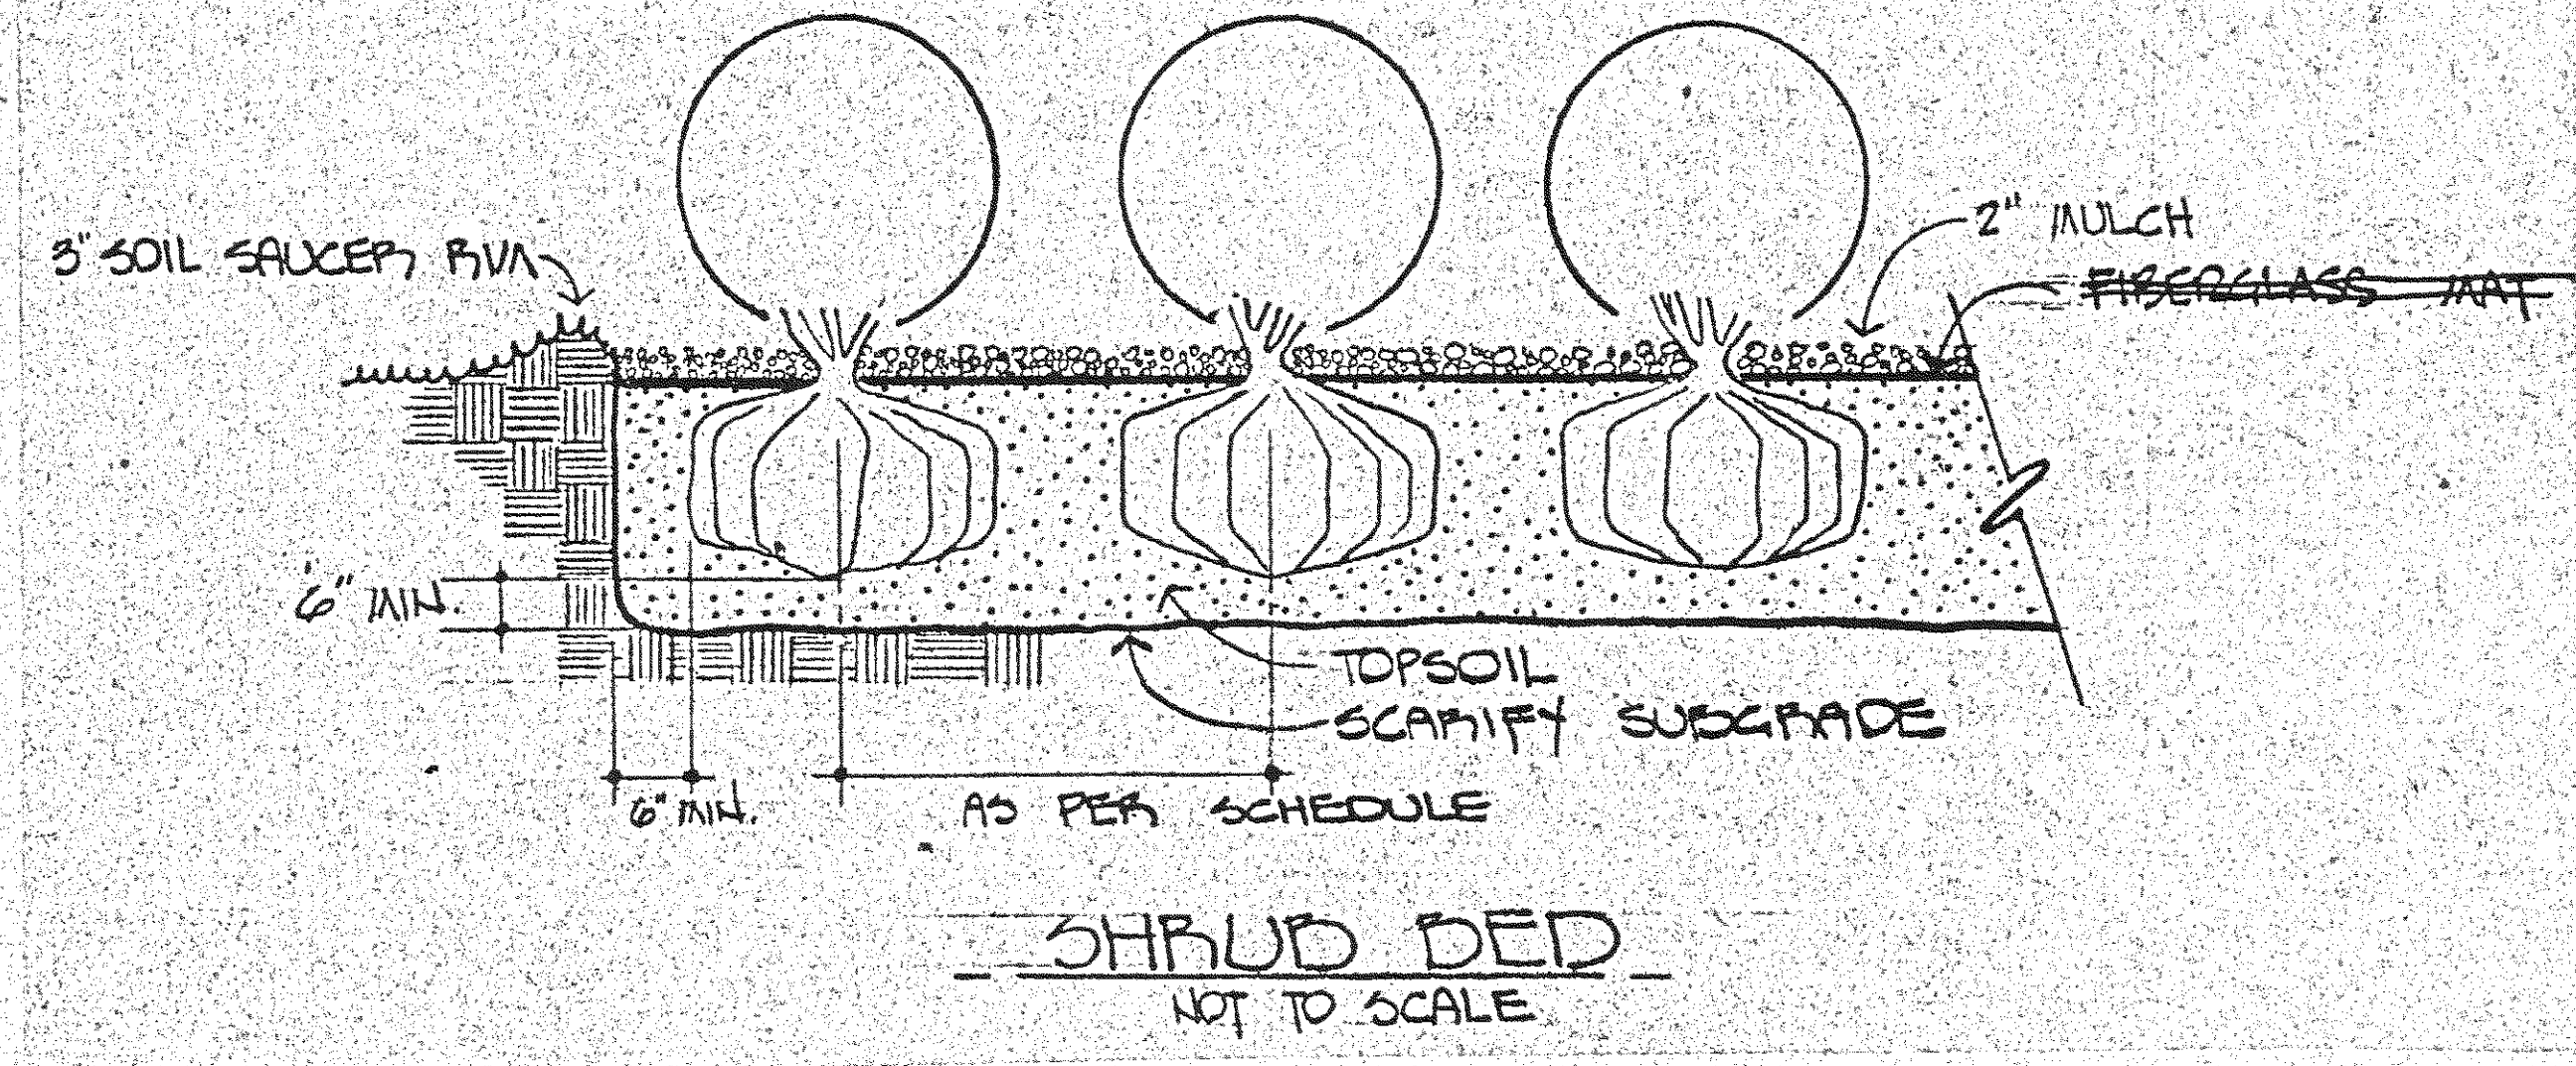


SHRUB BED NOT TO SCALE

NOTE: ALL DEPTHS SHOWN ARE AFTER COMPACTION. CONTRACTOR'S RESPONSIBILITY TO MAINTAIN THESE AREAS TILL COMPLETION OF JOB.

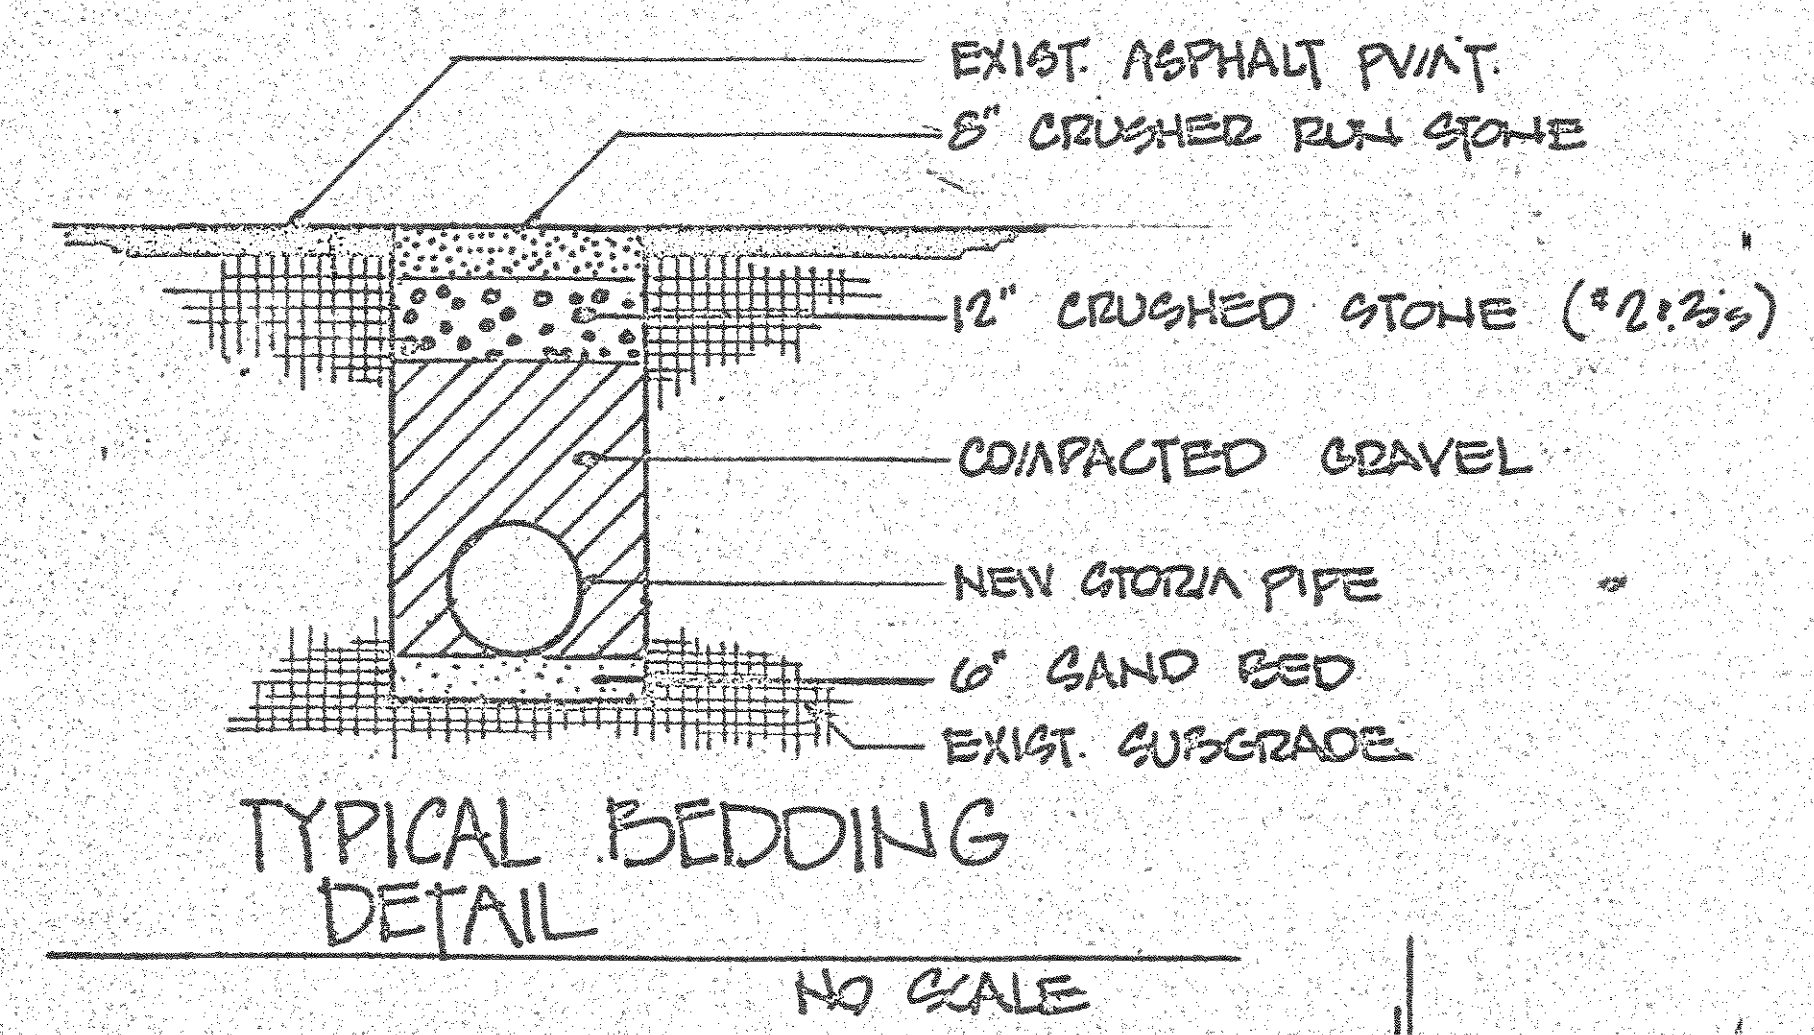

TYPICAL BEDDING DETAIL NO SCALE

EXISTING GULLY

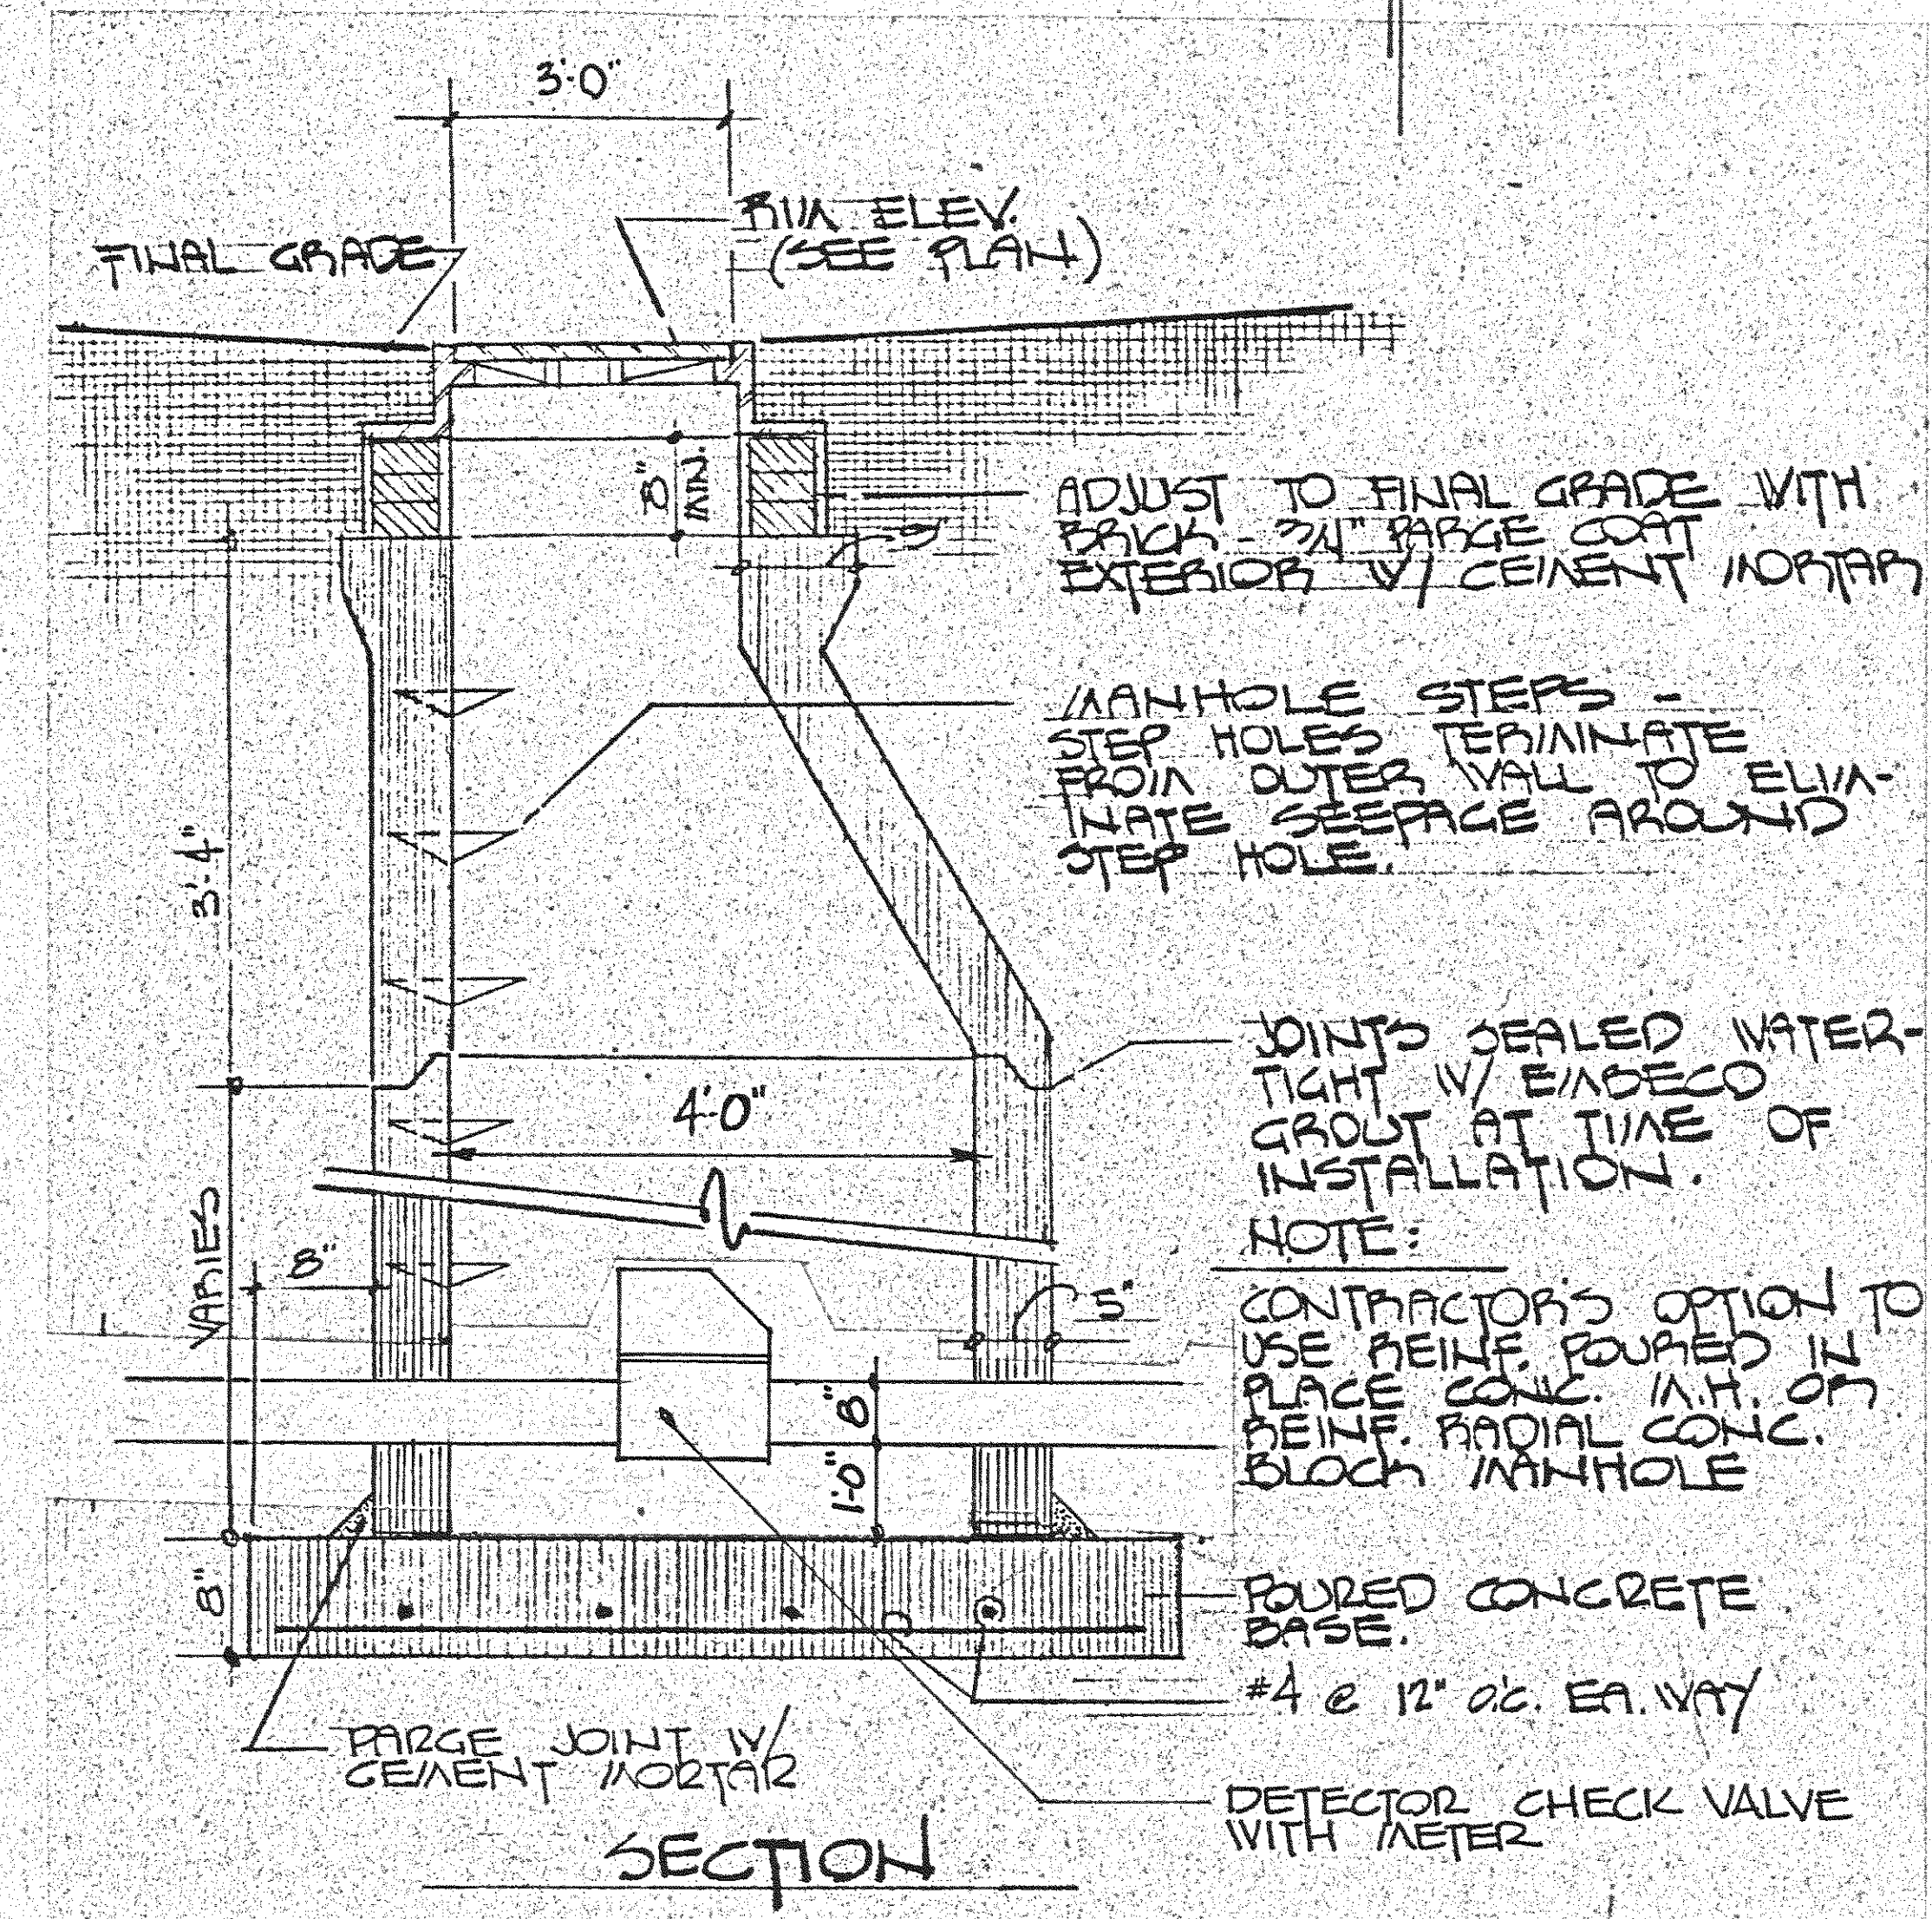



PRECAST CONC. MANHOLE DETAIL NO SCALE

NEW PLANTING AREA
 REPLACE TOP 1'-0\"/>

PROVIDE FOUNDATION HEDGE OF
 35 LEX CRENATA CONVEXA (BULLATA)
 - CONVEXIFOLIA JAPANESE HOLEY - 2'-0\"/>

AND
 GROUND COVER OF 400s JUNIPERUS
 HORIZONTALIS PLUNOSA (DEPRESSA PLUM)
 AND/OR JUNIPER - 1'-6\"/>


PROVIDE 2\"/>

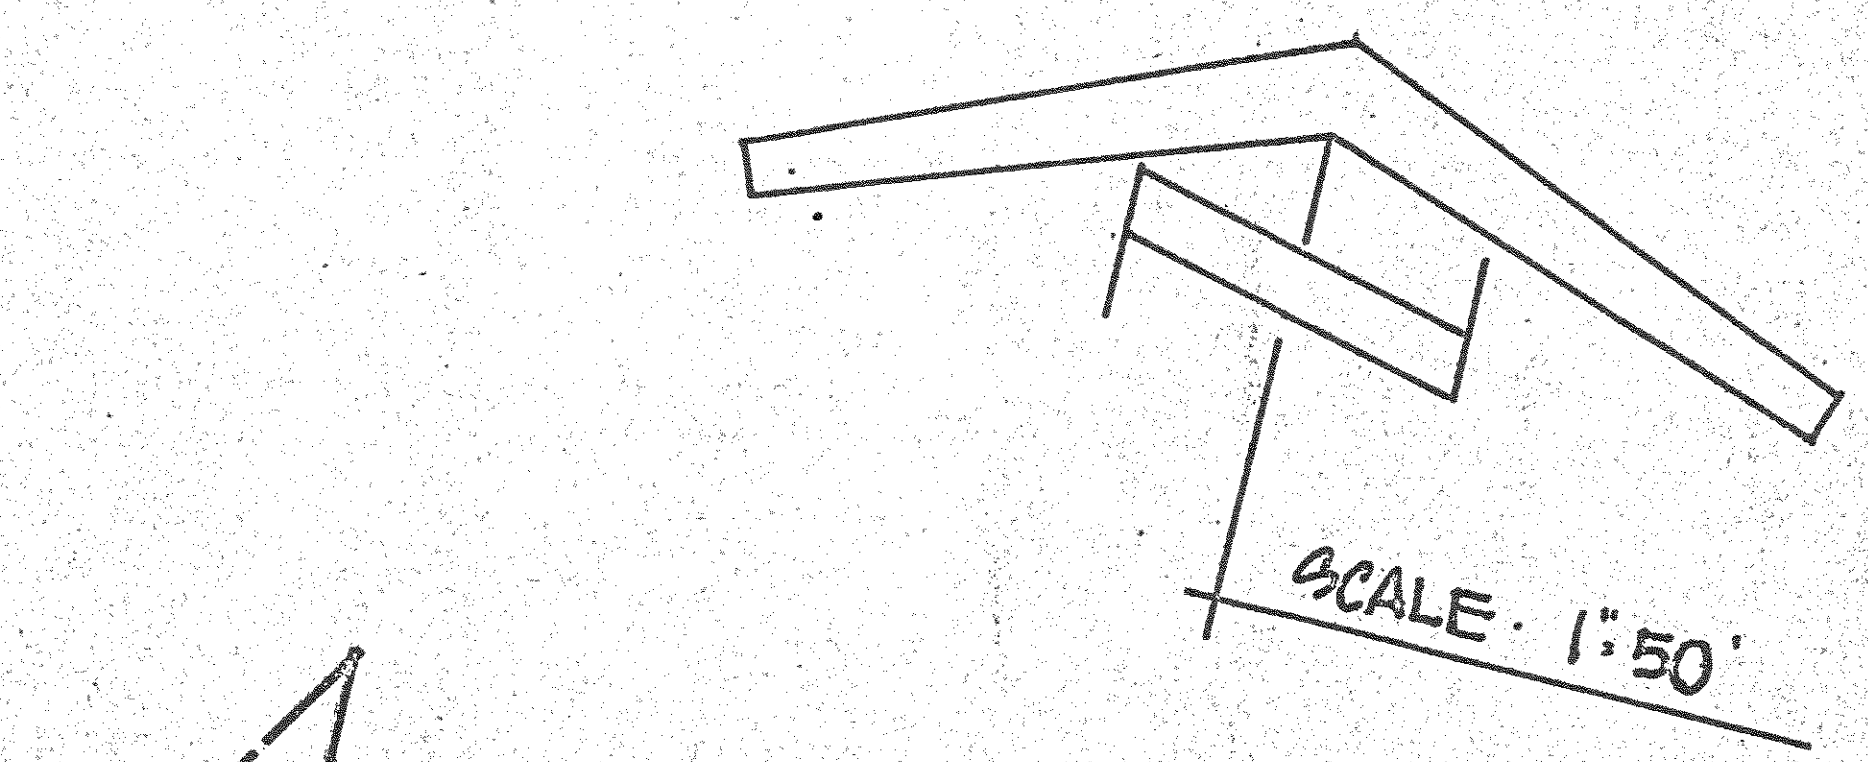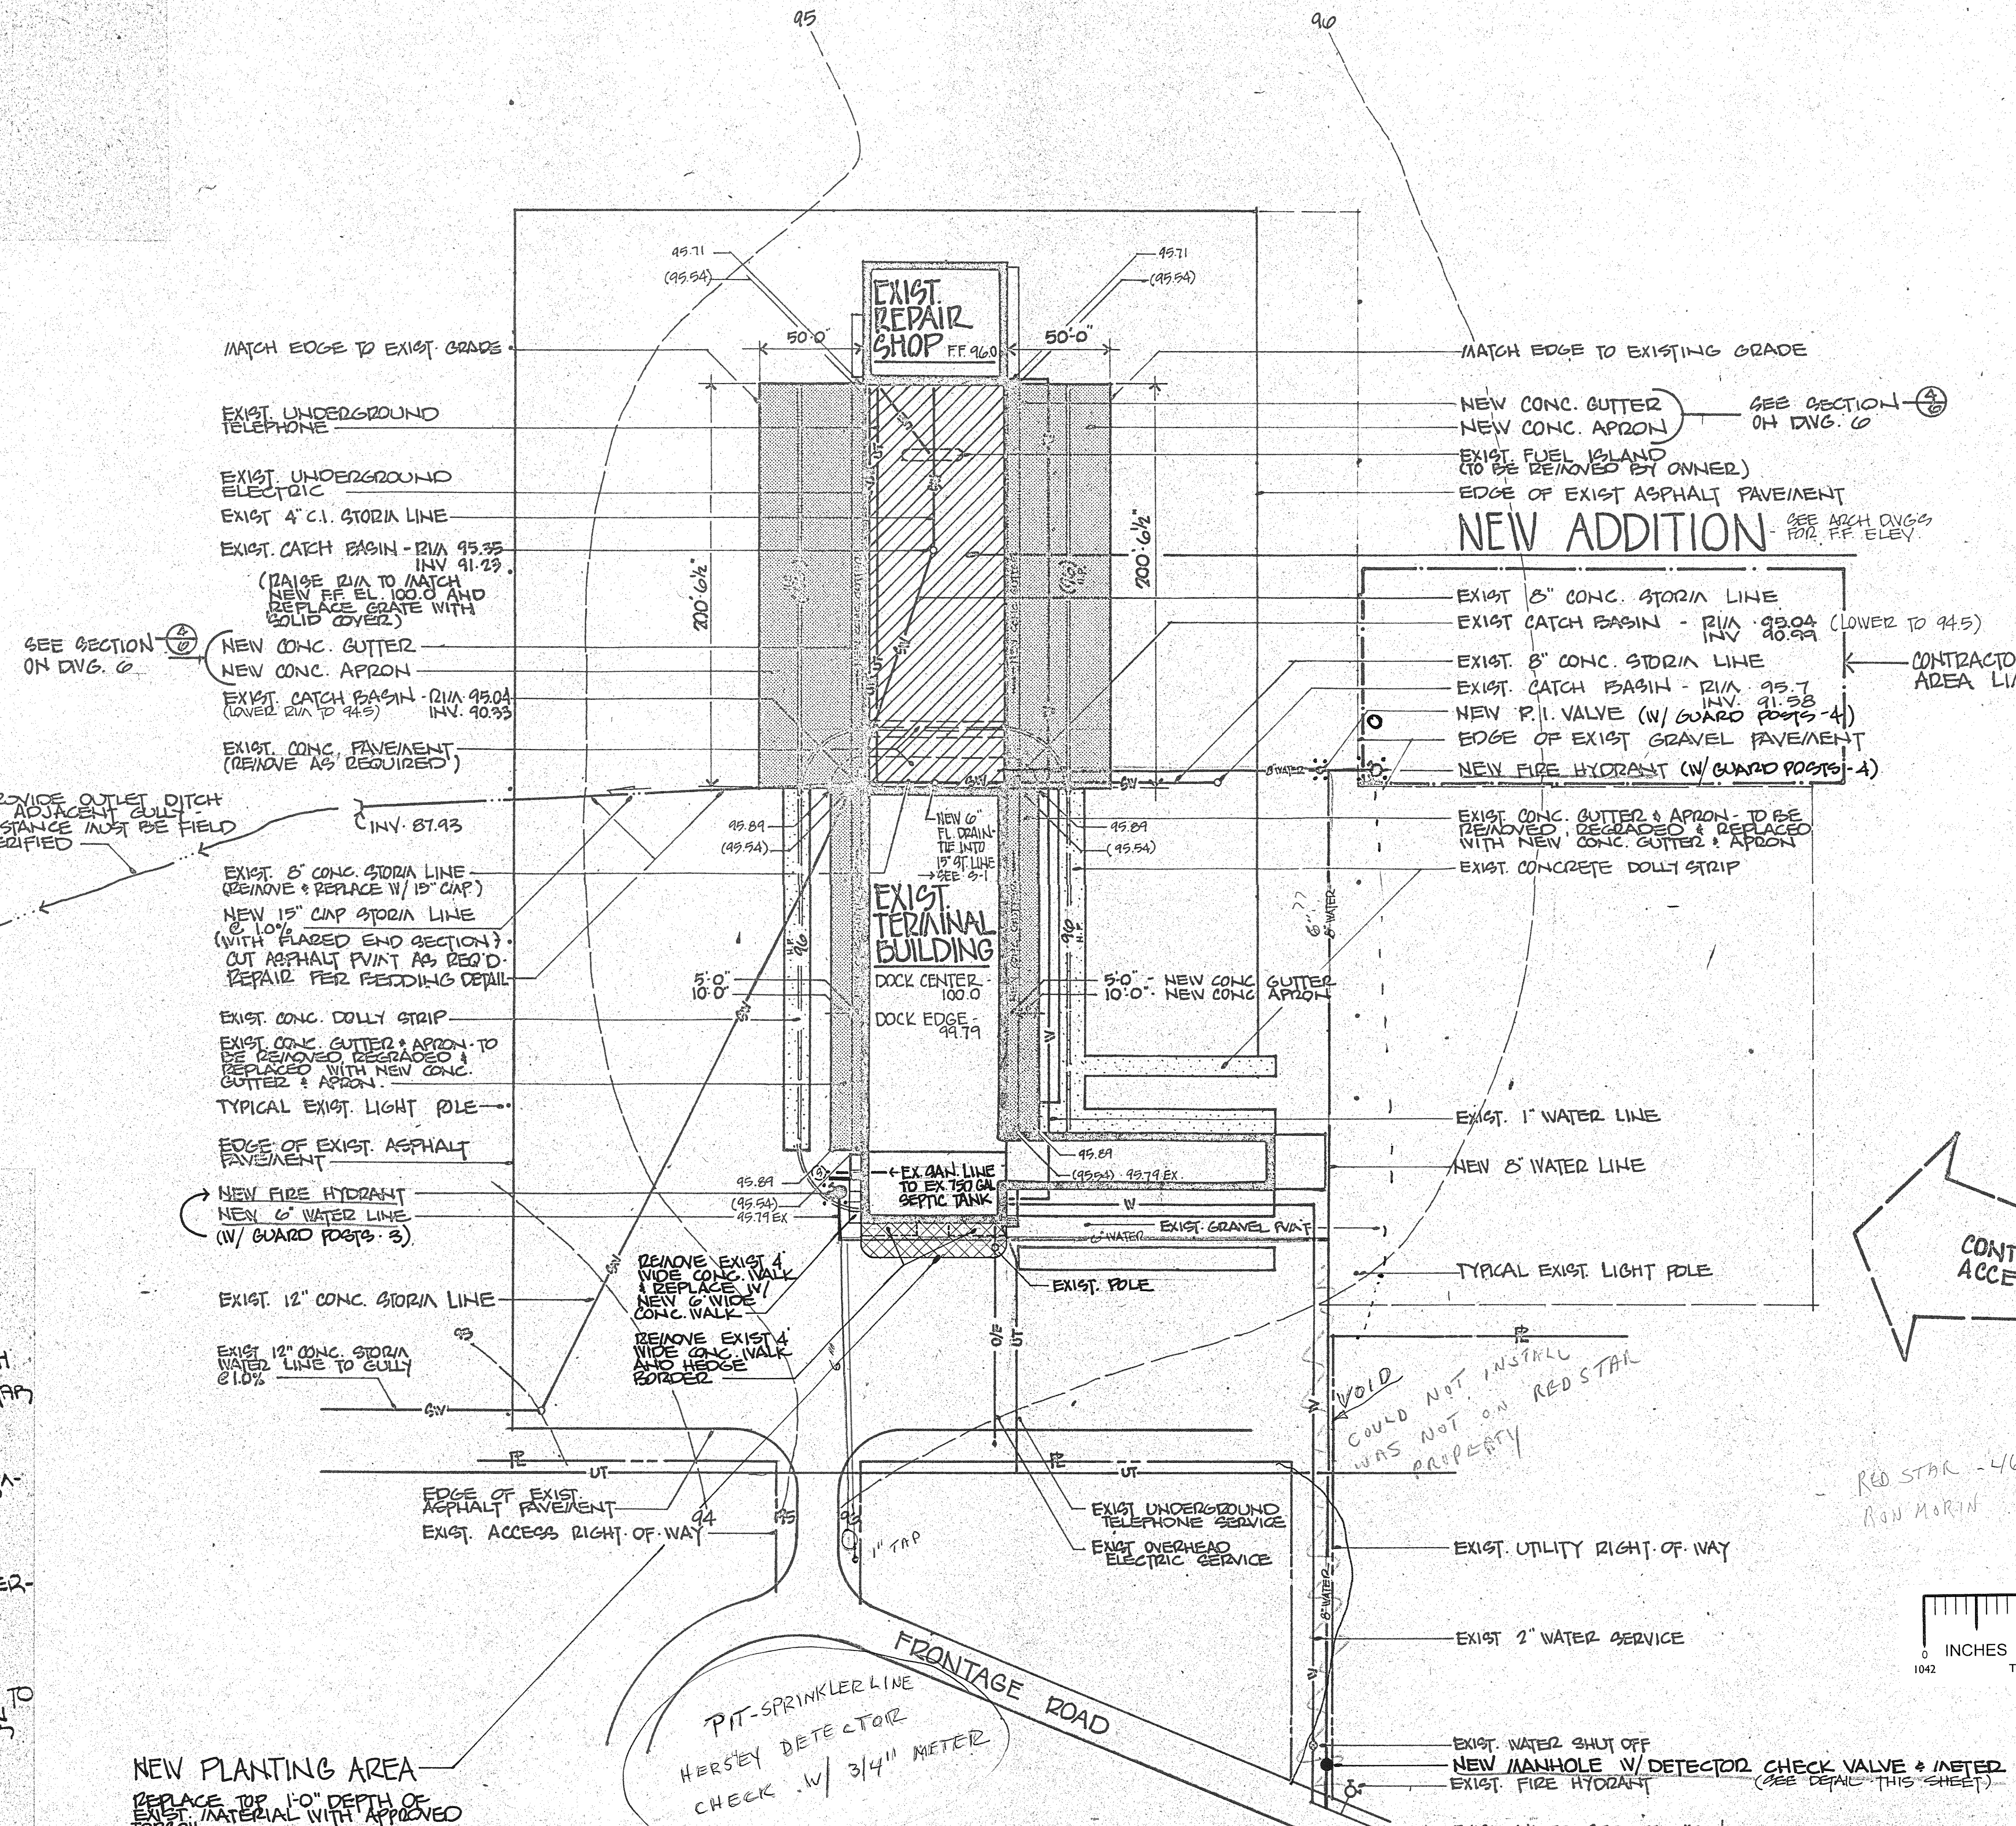

CONTRACTOR'S ACCESS

LEGEND

---	96	EXISTING GRADE
---	(96)	NEW GRADE
---	96	EXIST. SPOT GRADE
---	(96.2)	NEW SPOT GRADE
---	SN	EXIST. STORM WATER LINE
---	SN	NEW STORM WATER LINE
---	W	EXIST. WATER LINE
---	W	NEW WATER LINE
---	⊕	EXIST. HYDRANT
---	⊕	NEW HYDRANT
---	⊕	NEW RST INDICATOR VALVE (R.I.V.)
---	UT	EXIST. UNDERGROUND TELEPHONE
---	UE	EXIST. UNDERGROUND ELECTRIC
---	○	EXIST. CATCH BASIN
---	•	EXIST. LIGHT POLE
---	HP	HIGH POINT

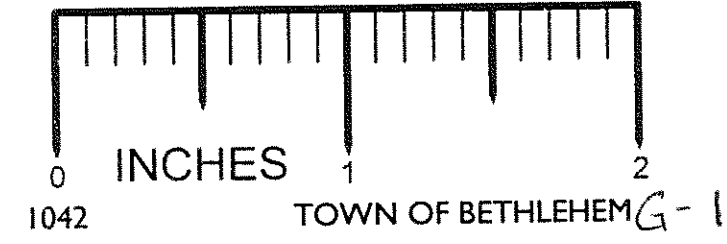

RED STAR - 4634203
 ROW MARK

6-1



ALBANY TERMINAL EXPANSION
 ROUTE 9W ALBANY, N.Y.
 RED STAR EXPRESS LINES, ALBANY, N.Y.

SITE PLAN

DRAWN BY: LWC CHECKED: JAS SCALE: 1"=50' DATE: 7/19/80 PROJECT NO.: 87-03

BEARDSLEY & BEARDSLEY • ARCHITECTS/ENGINEERS, P.C. • ALBANY, N.Y.