



329 GLENMONT ROAD TOWN OF BETHLEHEM ALBANY COUNTY, STATE OF NEW YORK

DRAWING INDEX:

DWG #	TITLE	REV #	DATE
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ATTACHMENT — BUILDING ELEVATIONS — BY OTHERS			

PROJECT INFORMATION

PROJECT NAME: _____ TRACTOR SUPPLY CO.
SITE ADDRESS: _____ TOWN SQUIRE PLAZA, 329 GLENMONT ROAD
TOWN OF BETHLEHEM, ALBANY COUNTY, NEW YORK
TAX MAP NUMBER: _____ 97.12-2-7

APPLICANT

SCHUYLER COMPANIES
596 NEW LOUDON ROAD
LATHAM, NEW YORK 12110



CODE COMPLIANCE:


ALL WORK AND MATERIALS SHALL BE PERFORMED AND INSTALLED IN ACCORDANCE WITH THE CURRENT EDITIONS OF THE FOLLOWING CODES AS ADOPTED BY THE LOCAL GOVERNING AUTHORITIES. NOTHING IN THESE PLANS IS TO BE CONSTRUED TO PERMIT WORK NOT CONFORMING TO THE LATEST EDITIONS OF THE FOLLOWING:

1. UNIFORM PLUMBING CODE
2. NATIONAL ELECTRIC CODE
3. LOCAL BUILDING CODE
4. TOWN/COUNTY ORDINANCES

ISSUED FOR:

SITE PLAN REVIEW

TOWN OF BETHLEHEM APPROVAL

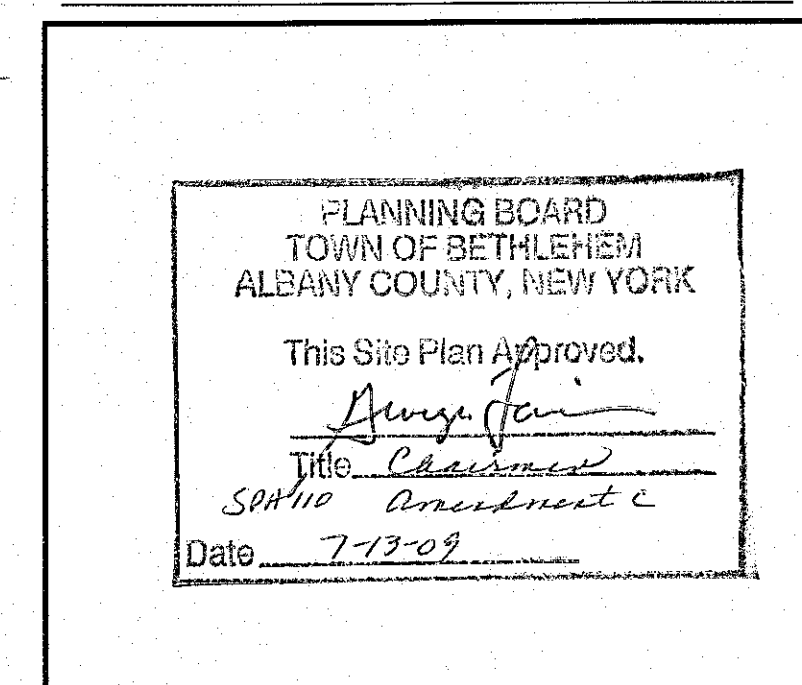


RECEIVED
JUL 10 2009
PLANNING BOARD
TOWN OF BETHLEHEM

DIG ALERT:
CALL FOR UNDERGROUND UTILITIES PRIOR TO DIGGING:
1-800-962-7962

EMERGENCY:
CALL 911

JULY, 2009

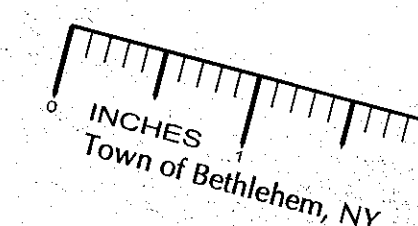

infinigy
engineering
& surveying

11 Herbert Drive
Latham, New York 12110
(518) 690-0790

Drawing Number



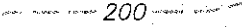

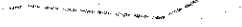

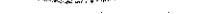

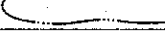



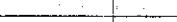

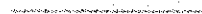



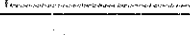
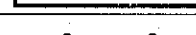



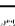





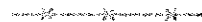



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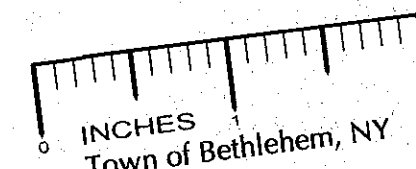
SPA 110C

1. UNDERGROUND UTILITIES ARE SHOWN BASED ON PHYSICAL EVIDENCE LOCATED AT THE GROUND SURFACE.
2. THE PLANS SHOW KNOWN SUBSURFACE STRUCTURES, ABOVEGROUND STRUCTURES AND/OR UTILITIES BELIEVED TO EXIST IN THE WORKING AREA, EXACT LOCATION CONTRACTOR IS WARNED THAT THE EXACT OR EVEN APPROXIMATE LOCATION OF SUCH DIFFERENT FORM THAT SHOWN OR MAY NOT BE SHOWN, AND IT SHALL BE HIS RESPONSIBILITY TO PROCEED WITH GREAT CARE IN EXECUTING ANY WORK. CONTRACTOR SHALL COMPLY WITH THE STATE OF NEW YORK DEPARTMENT OF PUBLIC SERVICE, 16NYCRR PART 753, EFFECTIVE FEBRUARY 5, 1997. CALL BEFORE YOU DIG @ 1-800-962-7962.
3. THE ENGINEER SHALL BE NOTIFIED IN WRITING OF ANY CONDITIONS THAT VARY FROM THOSE SHOWN ON THE PLANS. THE CONTRACTOR'S WORK SHALL NOT VARY FROM THE PLANS WITHOUT THE EXPRESSED APPROVAL OF THE ARCHITECT.
4. THE CONTRACTOR SHALL RESTORE LAWNS, DRIVEWAYS, CULVERTS, SIGNS AND OTHER PUBLIC OR PRIVATE PROPERTY DAMAGED OR REMOVED TO AT LEAST AS GOOD A CONDITION AS BEFORE BEING DISTURBED AS DETERMINED BY THE ARCHITECT. ANY DAMAGED TREES, SHRUBS, AND/OR HEDGES SHALL BE REPLACED AT THE CONTRACTOR'S EXPENSE.
5. THE CONTRACTOR SHALL COMPLY WITH ALL REQUIRED PERMITS.
6. THE CONTRACTOR SHALL BE RESPONSIBLE FOR OBTAINING AND INCURRING THE COST OF ALL REQUIRED PERMITS, INSPECTIONS, CERTIFICATES, ETC.
7. THE CONTRACTOR SHALL PROTECT EXISTING PROPERTY LINE MONUMENTATION. ANY MONUMENTATION DISTURBED OR DESTROYED, AS JUDGED BY THE ENGINEER OR OWNER, SHALL BE REPLACED AT THE CONTRACTOR'S EXPENSE UNDER THE SUPERVISION OF A NEW YORK STATE LICENSED LAND SURVEYOR.
8. ALL TRENCH EXCAVATION AND ANY REQUIRED SHEETING AND SHORING SHALL BE DONE IN ACCORDANCE WITH THE LATEST REVISIONS OF NEW YORK STATE CODE RULE 23 AND OSHA REGULATIONS FOR CONSTRUCTION.
9. CONTRACTOR SHALL BE RESPONSIBLE FOR DEWATERING AND THE MAINTENANCE OF SURFACE DRAINAGE DURING THE COURSE OF WORK.
10. MAINTAIN FLOW FOR ALL EXISTING UTILITIES, CULVERTS, AND DITCHES.
11. ALL MANHOLES, CASTINGS, ETC. AND VALVE BOXES WITHIN PAVED AREAS SHALL HAVE THE TOPS SET FLUSH WITH THE EXISTING PAVEMENT GRADE. IN LANDSCAPED AREAS, ALL FRAMES SHALL BE 0.1' ABOVE GRADE.
12. BEFORE CONSTRUCTING LINES TO CONNECT TO EXISTING UTILITIES OR UTILITIES INSTALLED UNDER OTHER CONTRACTS, VERIFY EXISTING UTILITY INVERTS AND NOTIFY ENGINEER IF ANY VARIATION FROM THE PLANS IS REQUIRED.
13. CONTRACTOR TO GRADE ALL AREAS ON THE SITE TO PROVIDE POSITIVE DRAINAGE.
14. THE CONTRACTOR SHALL BE RESPONSIBLE FOR PROVIDING ALL FIELD LAYOUT. THE CONTRACTOR SHALL TAKE TIES TO ALL UTILITY CONNECTIONS AND PROVIDE MARKED-UP AS-BUILT PLANS FOR ALL UTILITIES SHOWING TIES TO CONNECTIONS, BENDS, VALVES, LENGTHS OF LINES AND INVERTS. AS-BUILT PLANS SHALL BE REVIEWED BY THE OWNER AND HIS REPRESENTATIVES, AND THE CONTRACTOR SHALL PROVIDE ANY CORRECTION OR ADMISSIONS TO THE SATISFACTION OF THE OWNER AND HIS REPRESENTATIVES BEFORE UTILITIES WILL BE ACCEPTED.

ALL WORK AND MATERIALS SHALL BE PERFORMED AND INSTALLED IN ACCORDANCE WITH THE CURRENT EDITIONS OF THE FOLLOWING CODES AS ADOPTED BY THE LOCAL GOVERNING AUTHORITIES. NOTHING IN THESE PLANS IS TO BE CONSTRUED TO PERMIT WORK NOT CONFORMING TO THE LATEST EDITIONS OF THE FOLLOWING:

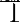15. THE CONTRACTOR SHALL EXERCISE CAUTION WHEN OPERATING CONSTRUCTION EQUIPMENT OVER NEW UTILITY TRENCHES. THE CONTRACTOR SHALL BE RESPONSIBLE FOR MAINTAINING A MINIMUM OF TWO FEET OR MORE, IF REQUIRED, OVER ANY UTILITY LINE SUBJECT TO CONSTRUCTION TRAFFIC.
16. CONTRACTOR SHALL BE RESPONSIBLE FOR COORDINATING ALL WORK, LANE CLOSURES AND DISRUPTIONS WITH GOVERNING AGENCIES.
17. PRIOR TO BIDDING PROJECT, THE CONTRACTOR SHALL VISIT THE SITE TO VERIFY EXISTING CONDITIONS.
18. ALL PHYSICAL FEATURES, INDIVIDUAL TREES, LANDSCAPING OR UTILITY LOCATIONS COULD NOT BE POSSIBLY SHOWN ON THE CONTRACT DRAWINGS. EACH BIDDER IS ENCOURAGED TO PERSONALLY INSPECT ALL AREAS OF PROPOSED WORK, IN ORDER TO ENSURE THAT HE IS FAMILIAR WITH THE PHYSICAL LAYOUT OF THE AREA AND THE REQUIREMENTS OF THE WORK.
19. PROPERTY LINES ARE APPROXIMATE AS INTERPOLATED FROM EXISTING MAPPING AND ARE SHOWN FOR REFERENCE ONLY. SEE LIST OF MAP REFERENCES FOR FURTHER INFORMATION.
20. ALL PROPOSED WORK MAY BE VARIED IN THE FIELD BY THE ENGINEER TO MEET EXISTING CONDITIONS.
21. UPON COMPLETION OF THE WORK, ALL DISTURBED AREAS SHALL BE RESTORED TO A CONDITION EQUAL TO OR BETTER THAN THAT WHICH EXISTED PRIOR TO CONSTRUCTION.
22. TURF ESTABLISHMENT: ALL DISTURBED, FILL OR CUT AREAS SHALL BE GRADED, SEEDED, AND MULCHED, WITHIN ONE WEEK OF BACK FILLING SHOULDER AREAS, AS SHOWN ON THE DETAILS, AND LAWN AREAS OF PRIVATE PROPERTY DISTURBED DURING THE COURSE OF THE WORK WILL REQUIRE TOP SOIL BEFORE SEEDING AND MULCHING. ANY AREAS THAT SETTLE OR WASH OUT SHALL BE REPAIRED.
23. WHERE PRACTICAL, ALL EROSION CONTROL MEASURES SHALL BE PUT INTO PLACE PRIOR TO BEGINNING CONSTRUCTION.
24. TRENCHES SHALL NOT BE LEFT OPEN OVERNIGHT. TEMPORARY PATCH SHALL BE PLACED AT THE END OF EACH WORKING DAY.
25. ALL CONSTRUCTION STAKE OUT SHALL BE THE RESPONSIBILITY OF THE CONTRACTOR. LOCATION OF MANHOLES, ARE TO BE INDIVIDUALLY STAKED OUT. SEWER MAIN TO BE STAKED OUT AT 100 FOOT STATIONS.
26. DIMENSIONS ARE FROM FACE OF CURB, FACE OF BUILDING, FACE OF WALL AND CENTERLINE OF PAVEMENT MARKINGS UNLESS OTHERWISE NOTED.
27. ALL WORK TO BE CONSTRUCTED PER THE TOWN OF BETHLEHEM TOWN STANDARDS.

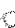LEGEND		
DESCRIPTION	EXISTING	PROPOSED
FENCE		
5' OR 10' CONTOUR LINE		
1' OR 2' CONTOUR LINE		
EDGE OF STREAM OR RIVER		
LAKE OR POND		
PROPERTY LINE		
SILT FENCE		
GRADING LIMITS		
EDGE OF PAVEMENT		
EDGE OF WOODS		
BUILDING		
STORM SEWER		
SANITARY SEWER		
WATER LINE		
CATCH BASIN		
MANHOLE		
HYDRANT		
WATER VALVE/CONTROL VALVE		
POWER POLE / UTILITY POLE		
WETLAND/MARSH		



1. "All utilities to be installed are shown on the Town Standard Details and Specifications. Prior to construction, the contractor shall obtain these two documents for use on the job."
2. "All elevations shown are on USGS elevation base."
3. "All grading to be 3:1 (horizontal:vertical) maximum slope. Graded lawn/yard areas shall have a minimum slope of 2%."
4. "Prior to any work in the Town right-of-way, the contractor shall obtain a highway work permit from the Town Highway Superintendent."
5. "Prior to any work in the County right-of-way, a highway work permit from the County of Albany Department of Public Works is required."
6. "Prior to any work in the State right-of-way, a highway work permit from the New York State Department of Transportation is required."
7. "Prior to any work on sanitary sewer and water, the contractor shall obtain the necessary permits from the Town Department of Public Works."
8. "Unless otherwise noted, the locations and footprint configurations of proposed dwellings, driveways and associated lot grading as shown on this plan are conceptual and are included for municipal review purposes. Actual building locations and configurations, and related site grading, may vary from what is shown. However, any substantial variation from what is shown on any lot, as determined by the Town Building Inspector, shall be subject to further review by the Town Department of Public Works (and possibly other Town entities) prior to the issuance of a Building Permit for that lot."
9. "Any lot that has a proposed house location or building envelope that is located on the downhill side of the Safe Set Back Line will need to have a site-specific soils report submitted to the Building Inspector before a building permit will be issued for that lot."
10. "All controlled fill shall be certified by a licensed soils engineer, that placement of the material was done in a manner suitable for the construction of the road and the installation of water main, storm sewers, and sanitary sewers. To this end, no fill shall be placed in areas identified on these plans as controlled fill areas until the certifying soils engineer has been consulted."
11. "For all lots that have areas designated as preserved Federal Wetlands as shown on the Plans, the Town has no control over and accepts no responsibility for future drainage problems that could occur in these areas. This pertains whether such problems are a result of leaving the areas as they presently exist, or a result of future lot owners filling in and around the areas without regard for local drainage patterns."
12. "For all lots having preserved Federal Wetlands, such wetlands will be shown on the plot plans submitted to the Town Building Department for a Building Permit. This wetland information can be taken directly from the plat or Federal Wetlands Map. Said plot plans shall note that further filling of wetlands may require authorization from Federal regulatory authorities."
13. The contractor shall call the U.F.P.O. (1-800 962-7962) two working days prior to any excavation to have underground utilities located in the field."
14. Street right-of-way monuments shall be installed following completion of home construction at points designated by the Town of Bethlehem."
15. No sump pump, roof drains, cellar drains, or footing drains shall be connected to the sanitary sewer system."

PLANNING BOARD
TOWN OF BETHLEHEM
ALBANY COUNTY, NEW YORK



This Site Plan Approved.

George J. ...

Title *Chairman*

SPR No *Amendment c*

Date *7-12-09* _____

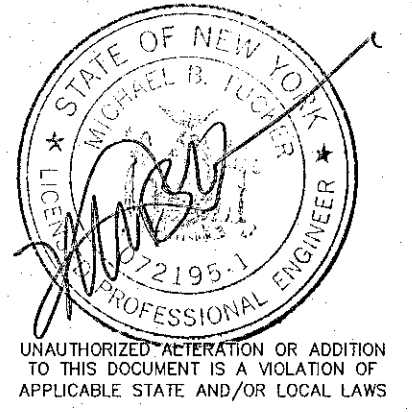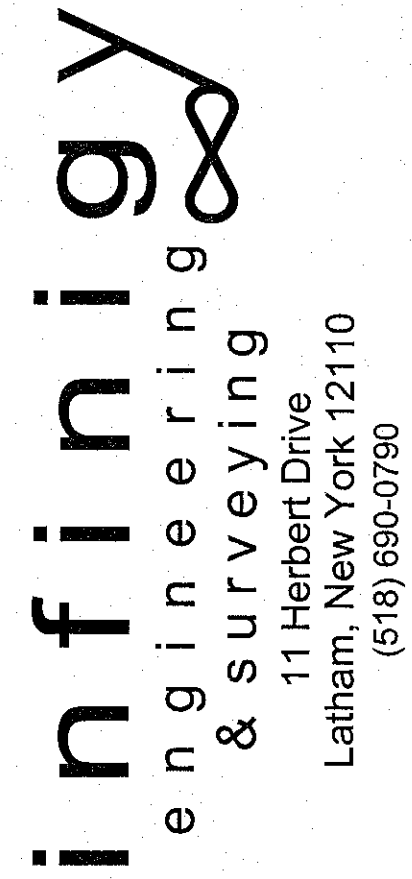

0	-	-	-
No.	Submittal / Revision	App'd	Date

Drawn: JDF Date: 04/09
Designed: MBT Date: 04/09
Checked: MBT Date: 04/09

Project Number 182-092

Project Title

Tractor Supply
Town Squire
Plaza

329 Glenmont Road
Town of Bethlehem
Albany Co., New York

Prepared For

Schuyler
Companies

596 New Loudon Road
Latham, New York 12110




Drawing Title

Legend and General Notes


Drawing Scale: _____

Date: 06-22-2009

The seal is circular with a double-lined border. Inside the border, the words "FLORIDA" and "REGISTERED PROFESSIONAL ENGINEER" are written in a circular path. In the center of the seal is a five-pointed star.

Drawing Number

C-1

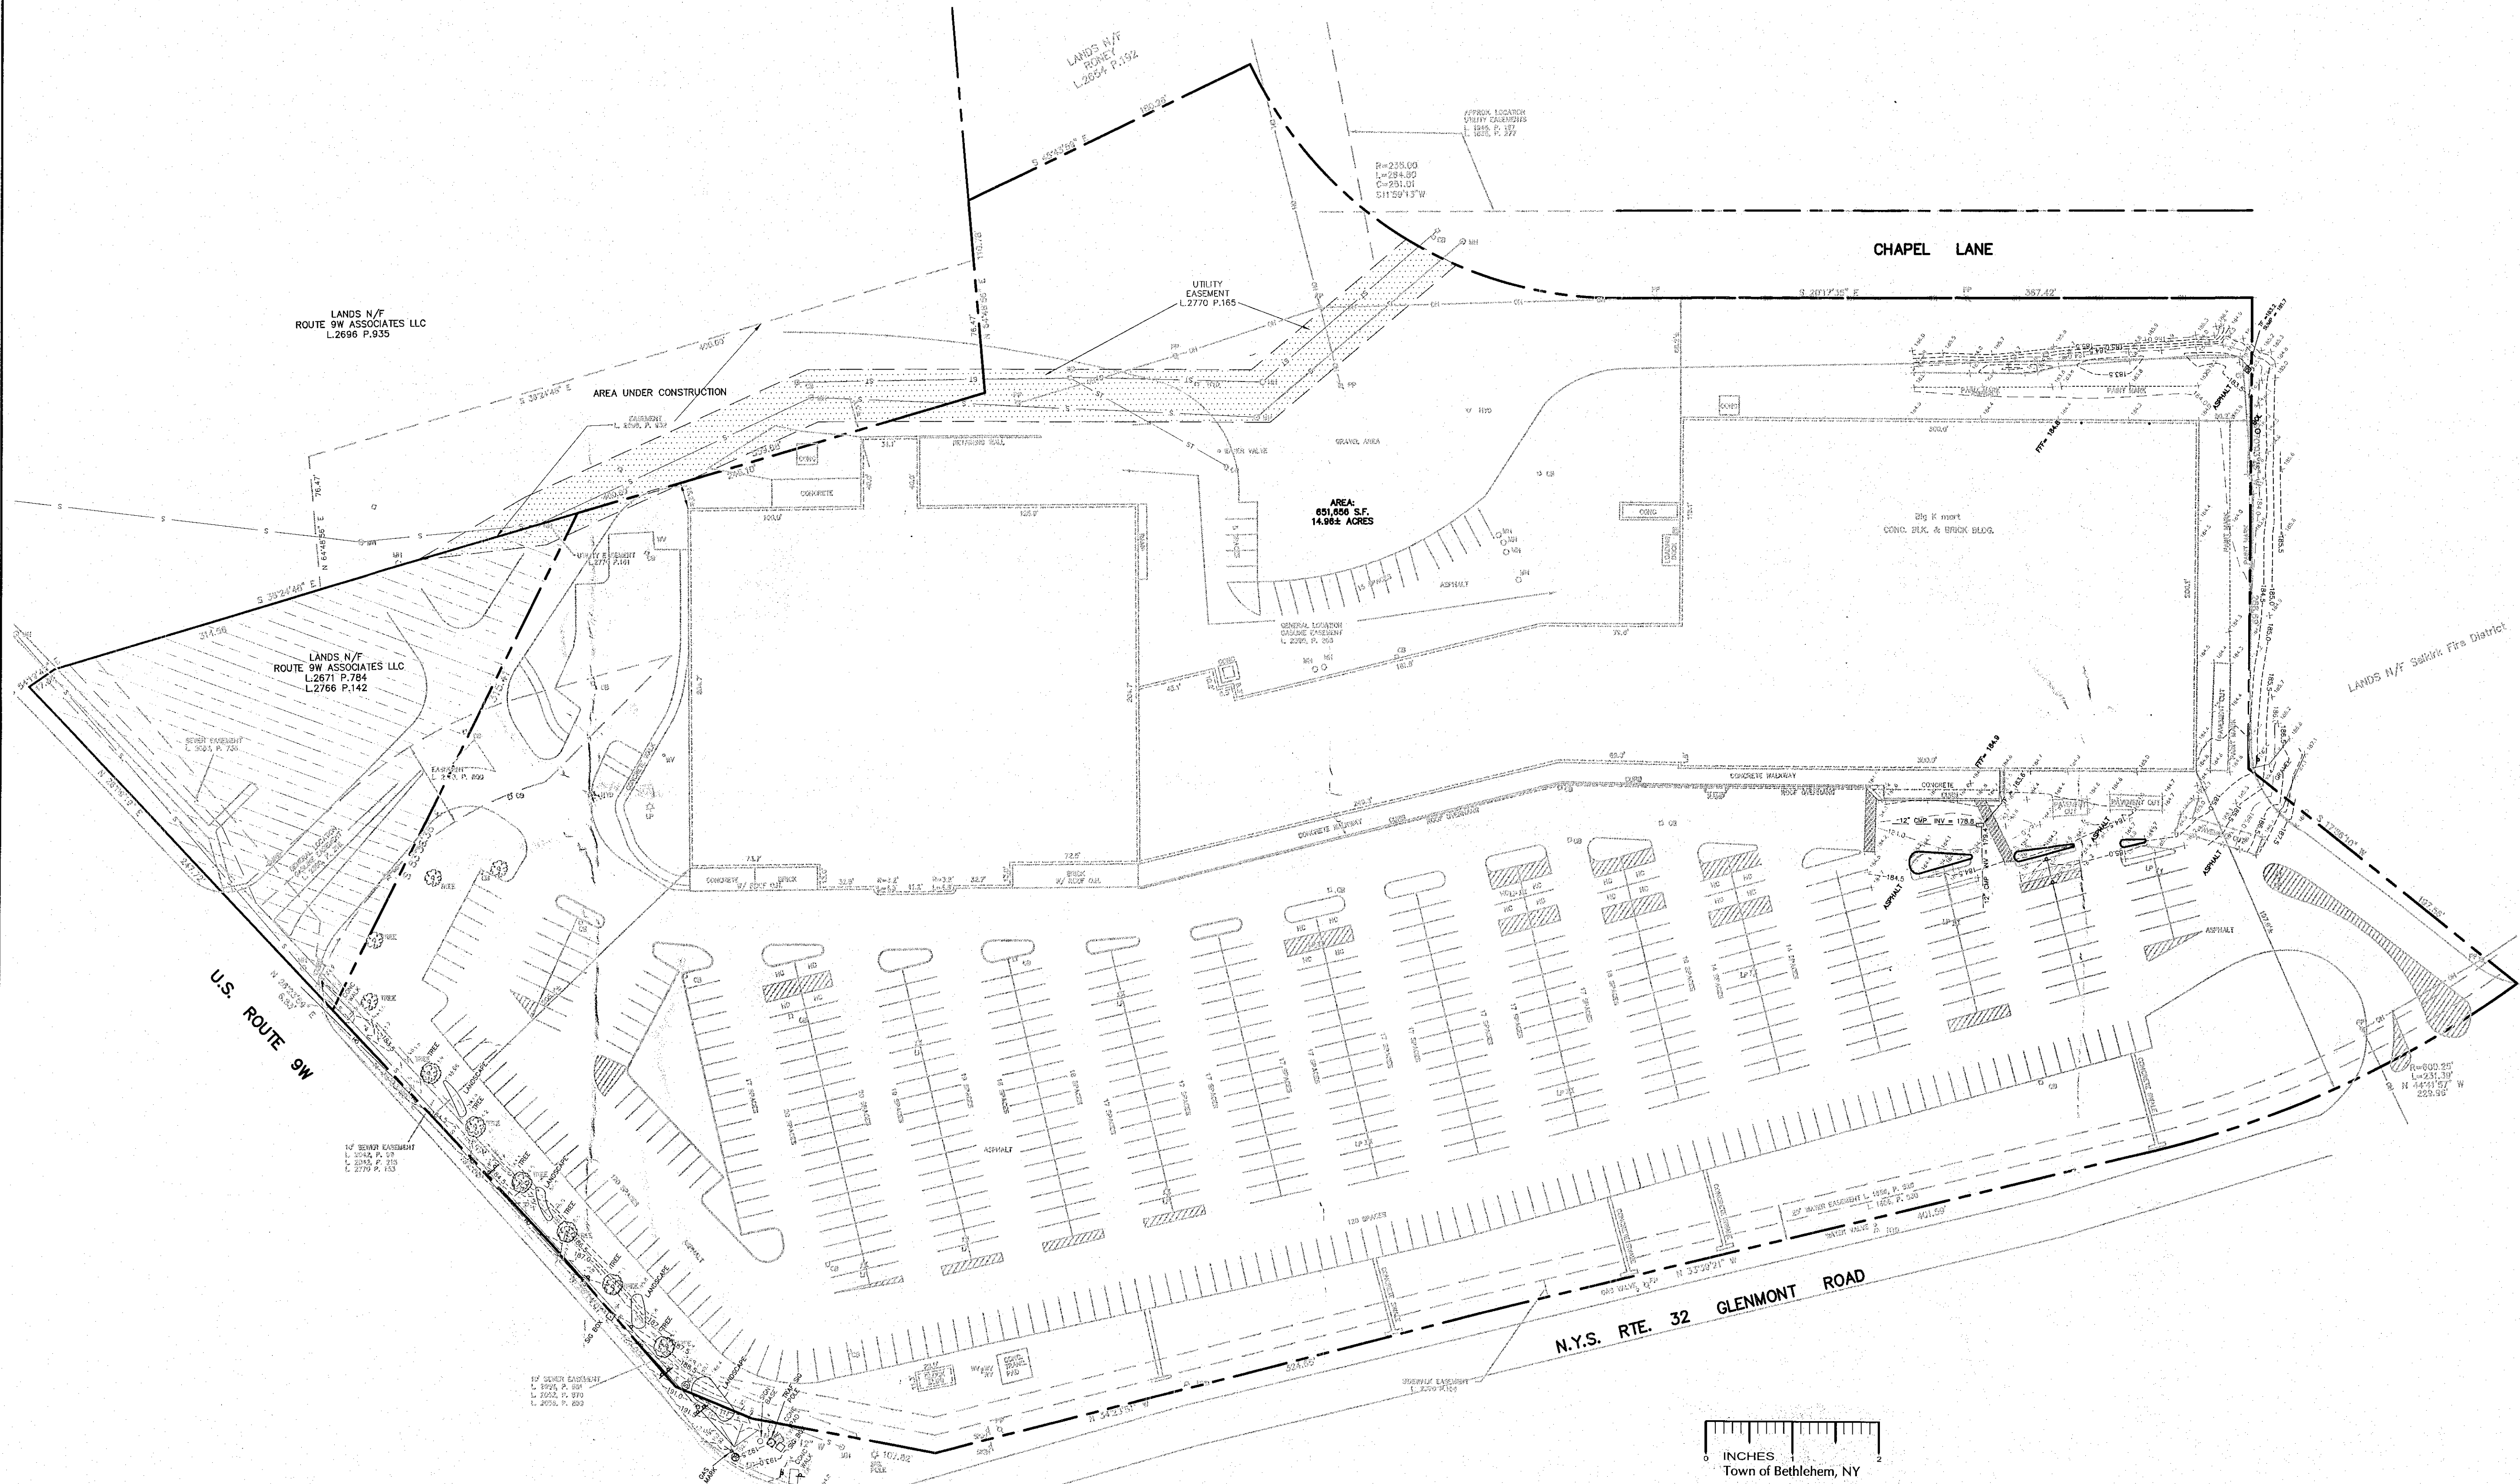

NOTE:
ELEVATIONS AND CONTOURS SHOWN ARE BASED UPON INFORMATION PROVIDED BY THE TOWN OF BETHLEHEM FOR BENCHMARK NO. 73 - BETHLEHEM SEWER DISTRICT DATED JANUARY 27, 1971. ELEVATION BASE IS NAVD 1988. BENCHMARK IS A HYDRANT WITH AN "X-CUT" AT THE NUT AT HEAD OF ARROW AND LOCATION NEAR THE INTERSECTION OF WEISER STREET AND GLENMONT ROAD IN FRONT OF FIRE COMPANY NO. 2.

DISTRICT INFORMATION	
SCHOOL DISTRICT	GLENMONT
FIRE DISTRICT	SELKIRK
SEWER DISTRICT	TOWN OF BETHLEHEM SEWER DISTRICT
WATER DISTRICT	TOWN OF BETHLEHEM DISTRICT 1
ZONING DISTRICT	COMMERCIAL HAMLET

infinigy

engineering & surveying

11 Herbert Drive
Latham, New York 12110
(518) 690-0790

STATE OF NEW YORK

SEAL

PROFESSIONAL ENGINEER

UNAUTHORIZED ALTERATION OR ADDITION TO THIS DOCUMENT IS A VIOLATION OF APPLICABLE STATE AND/OR LOCAL LAWS

No.	Submittal / Revision	App'd	Date
0	-	-	-

Drawn: JDF Date: 04/09

Designed: MBT Date: 04/09

Checked: MBT Date: 04/09

Project Number

182-092

Project Title

Tractor Supply Town Squire Plaza

329 Glenmont Road
Town of Bethlehem
Albany Co., New York

Prepared For

Schuyler Companies

596 New Loudon Road
Latham, New York 12110

TRACTOR SUPPLY CO

Drawing Title

Existing Conditions Plan

Drawing Scale:


1" = 50'

Date:

06-22-2009

Drawing Number

C-2

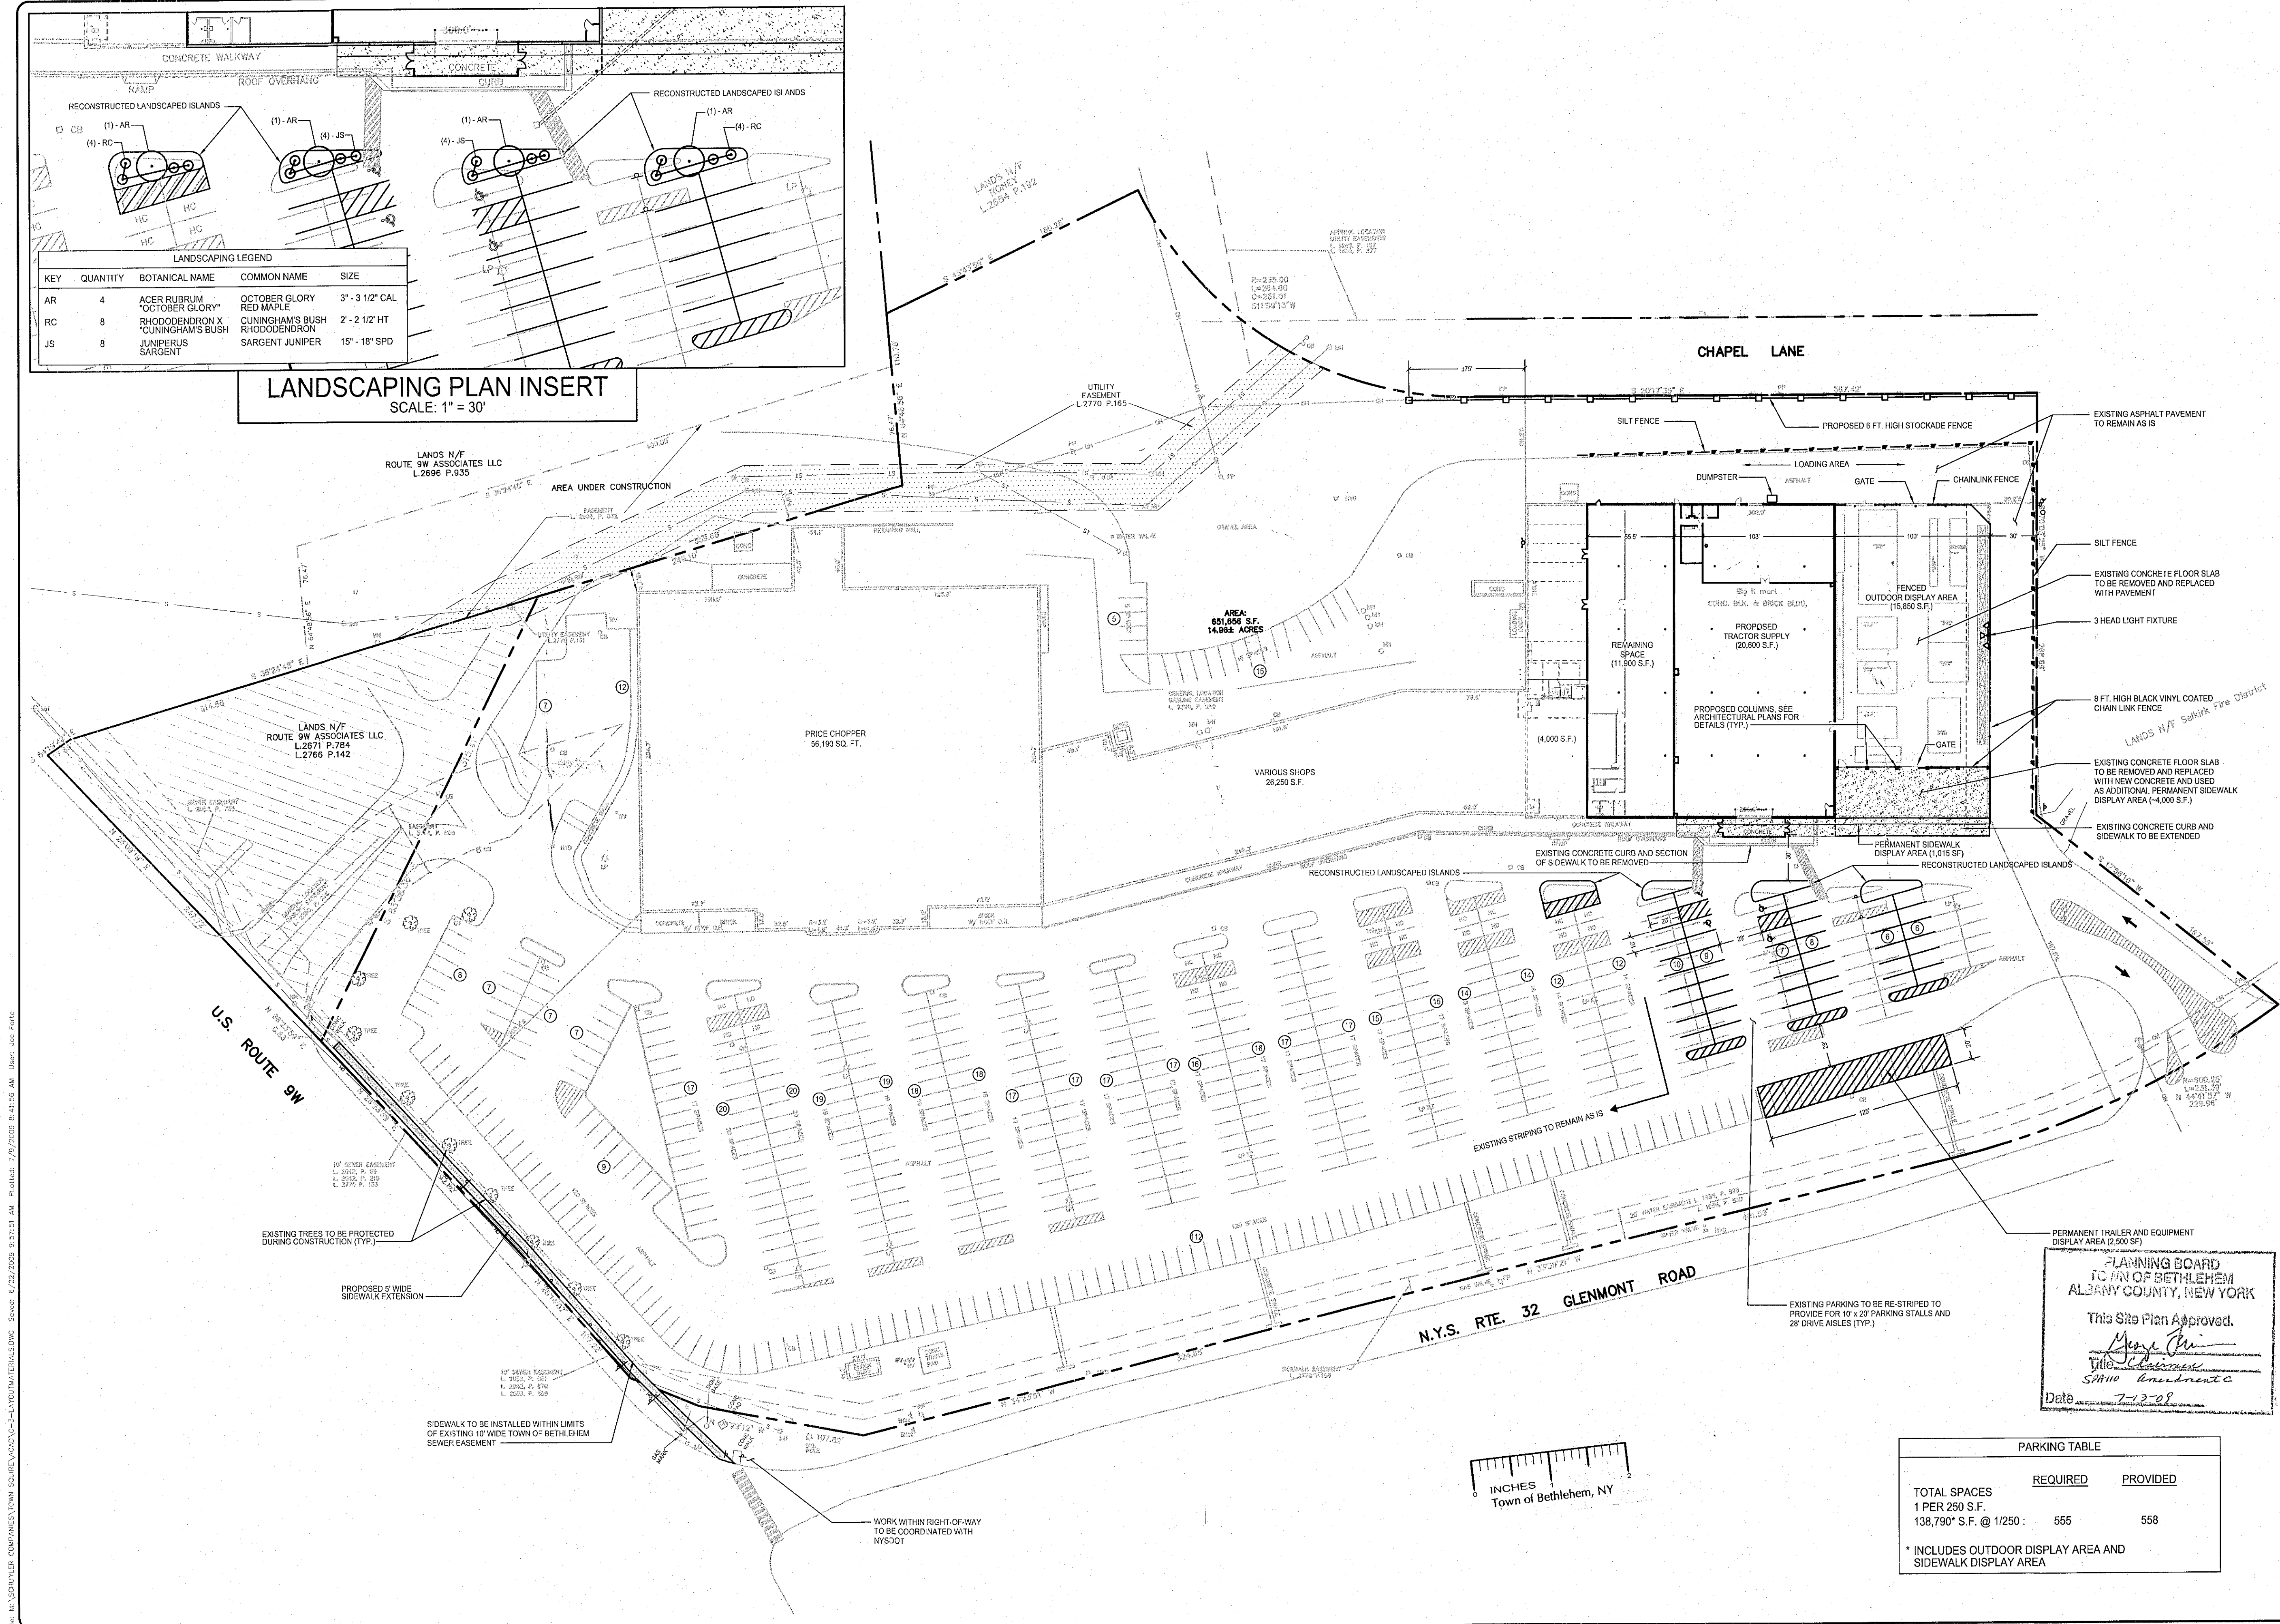


LANDSCAPING PLAN INSERT
SCALE: 1" = 30'

LANDSCAPING LEGEND				
KEY	QUANTITY	BOTANICAL NAME	COMMON NAME	SIZE
AR	4	ACER RUBRUM "OCTOBER GLORY"	OCTOBER GLORY RED MAPLE	3" - 3 1/2" CAL
RC	8	RHODODENDRON X "CUNNINGHAM'S BUSH"	CUNNINGHAM'S BUSH RHODODENDRON	2' - 2 1/2' HT
JS	8	JUNIPERUS SARGENT	SARGENT JUNIPER	15" - 18" SPD

PLANNING BOARD
TOWN OF BETHLEHEM
ALBANY COUNTY, NEW YORK
This Site Plan Approved.
[Signature]
Title: *Chairman*
SMA110 Amendment C
Date: 7-12-09

PARKING TABLE		
	REQUIRED	PROVIDED
TOTAL SPACES		
1 PER 250 S.F.		
138,790* S.F. @ 1/250 :	555	558
* INCLUDES OUTDOOR DISPLAY AREA AND SIDEWALK DISPLAY AREA		

infinity
engineering
& surveying
11 Herbert Drive
Latham, New York 12110
(518) 690-0790

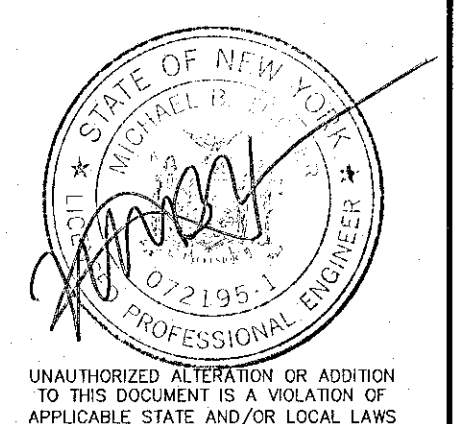

No.	Submitted / Revision	App'd	Date
0			

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Designed: MBT Date: 04/09
Checked: MBT Date: 04/09

Project Number 182-092

Project Title
**Tractor Supply
Town Squire
Plaza**

329 Glenmont Road
Town of Bethlehem
Albany Co., New York


Prepared For
**Schuyler
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Latham, New York 12110




Drawing Title
**Layout and
Materials Plan**

Drawing Scale:
1" = 50'
Date:
06-22-2009

Drawing Number
C-3

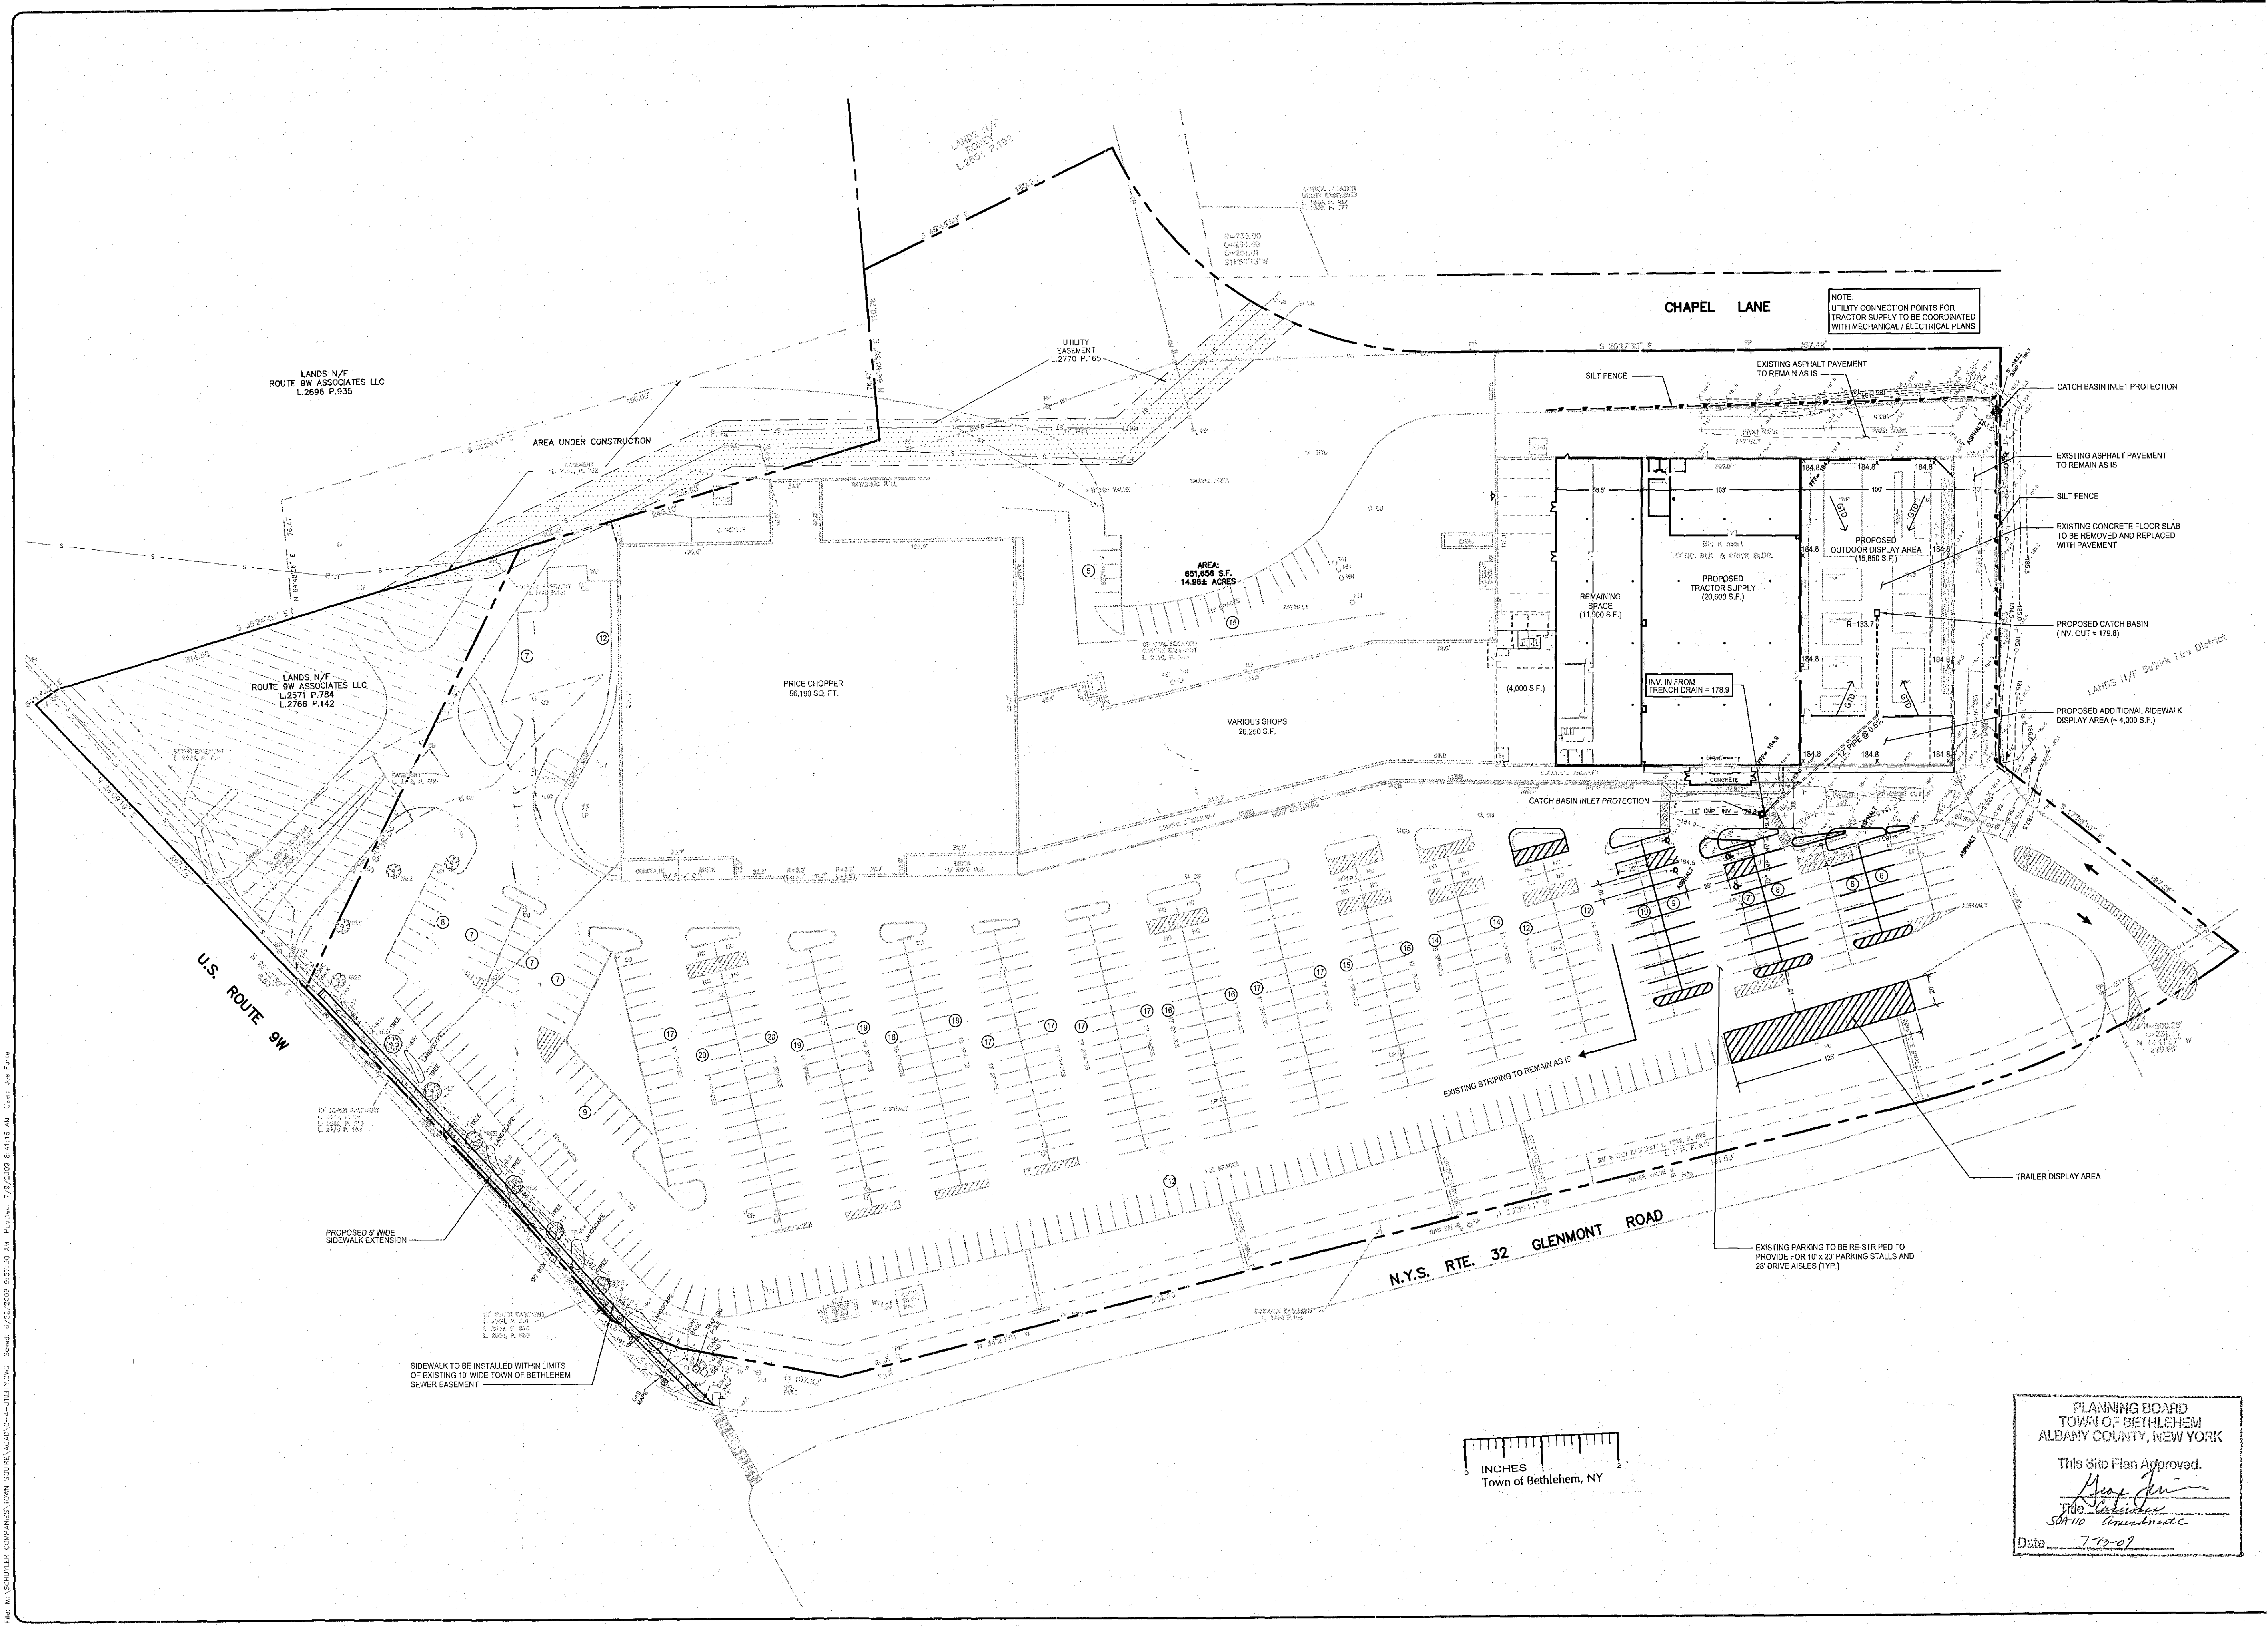

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& surveying
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Latham, New York 12110
(518) 690-0790

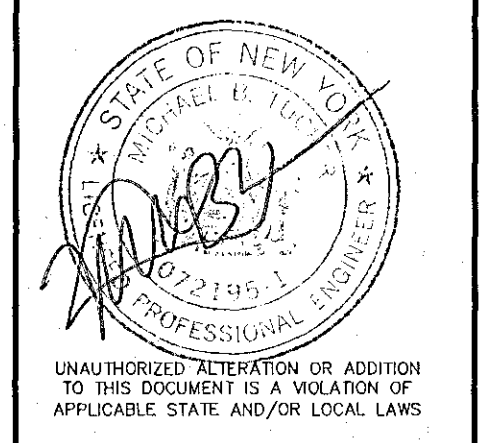

No.	Submital / Revision	App'd	Date
0			
Drawn:	JF	Date:	04/09
Designed:	MBT	Date:	04/09
Checked:	MBT	Date:	04/09

Project Number
182-092

Project Title
**Tractor Supply
Town Squire
Plaza**

329 Glenmont Road
Town of Bethlehem
Albany Co., New York

Prepared For
**Schuyler
Companies**
596 New Loudon Road
Latham, New York 12110




Drawing Title
**Grading and
Utility Plan**


Drawing Scale:
1" = 50'
Date:
06-22-2009

Drawing Number
C-4


File: S:\SCHUYLER COMPANIES\TOWN SQUIRE\LAUDON\SP110C\REL\DWG\SP110C-04.DWG
Scale: 1/8" = 1'-0" (1/8" = 1'-0")
Sheet: 4/22/2009 09:25:31 AM
Plotted: 7/19/2009 8:41:18 AM
User: jay.ford

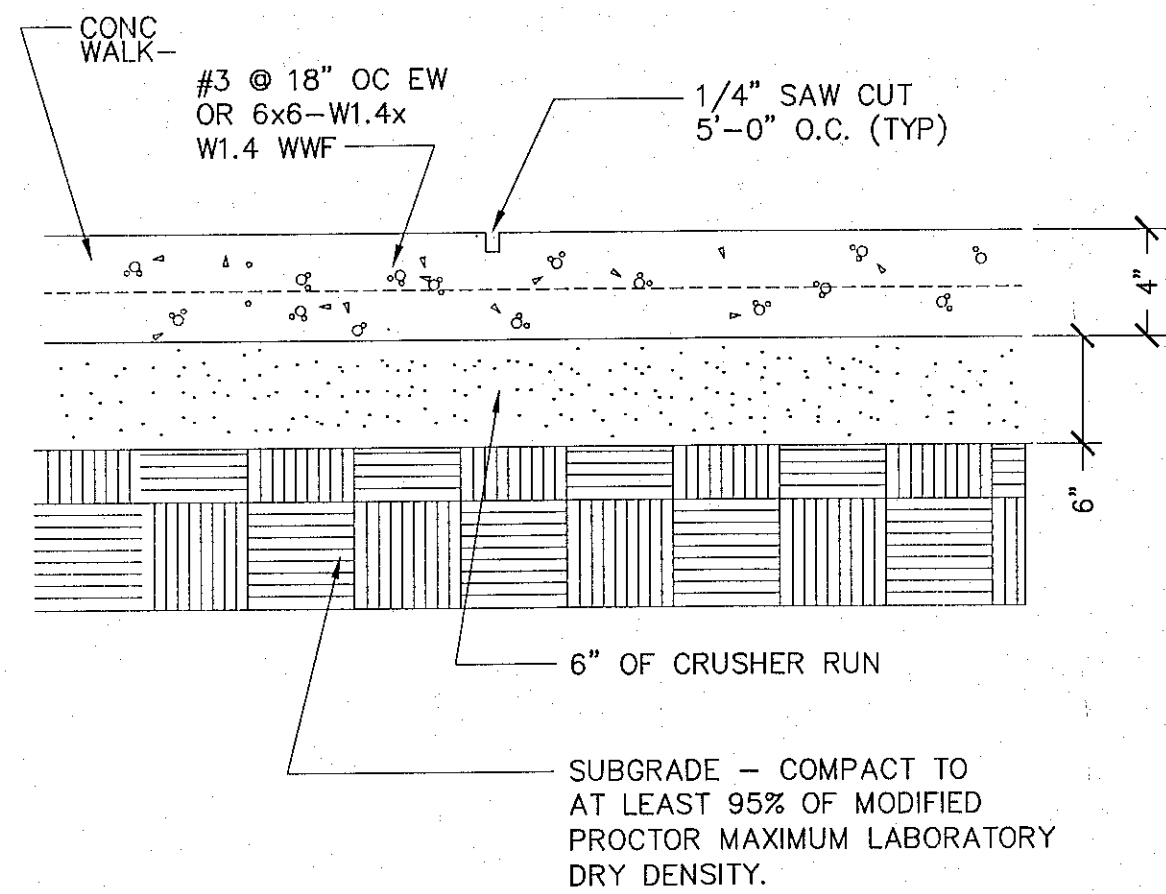


TYPICAL SIDEWALK SECTION
NO SCALE

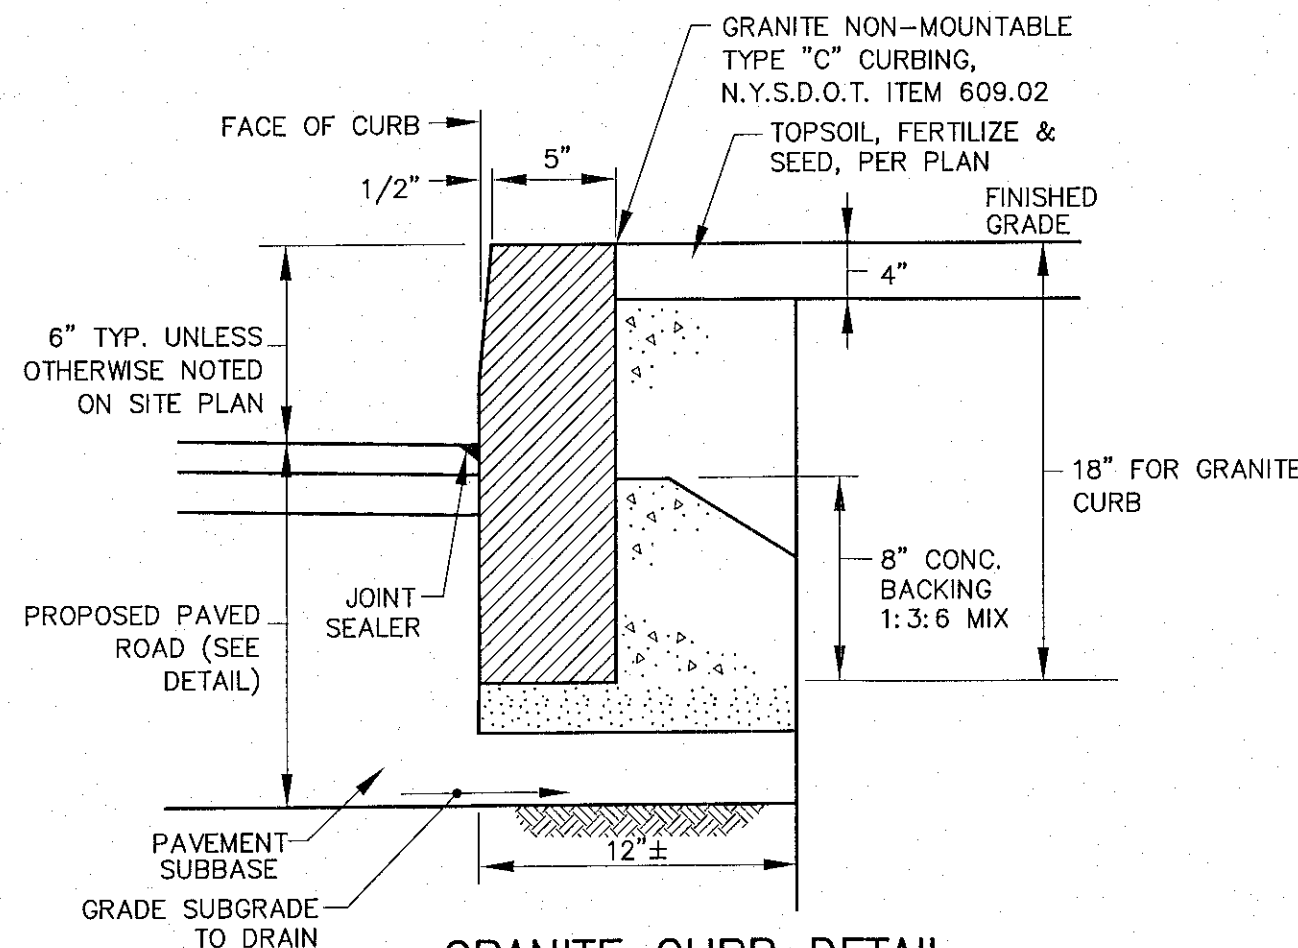


GRANITE CURB DETAIL
NO SCALE

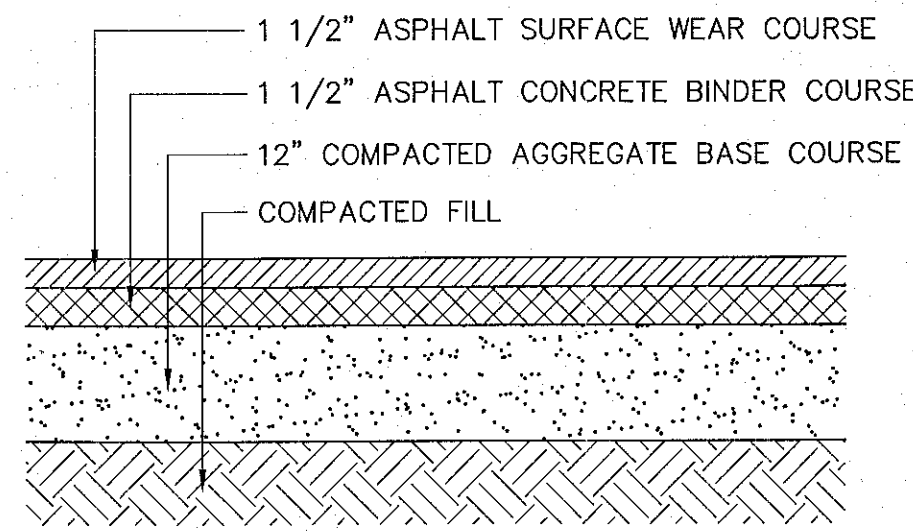

PAVEMENT SECTION
NOT TO SCALE

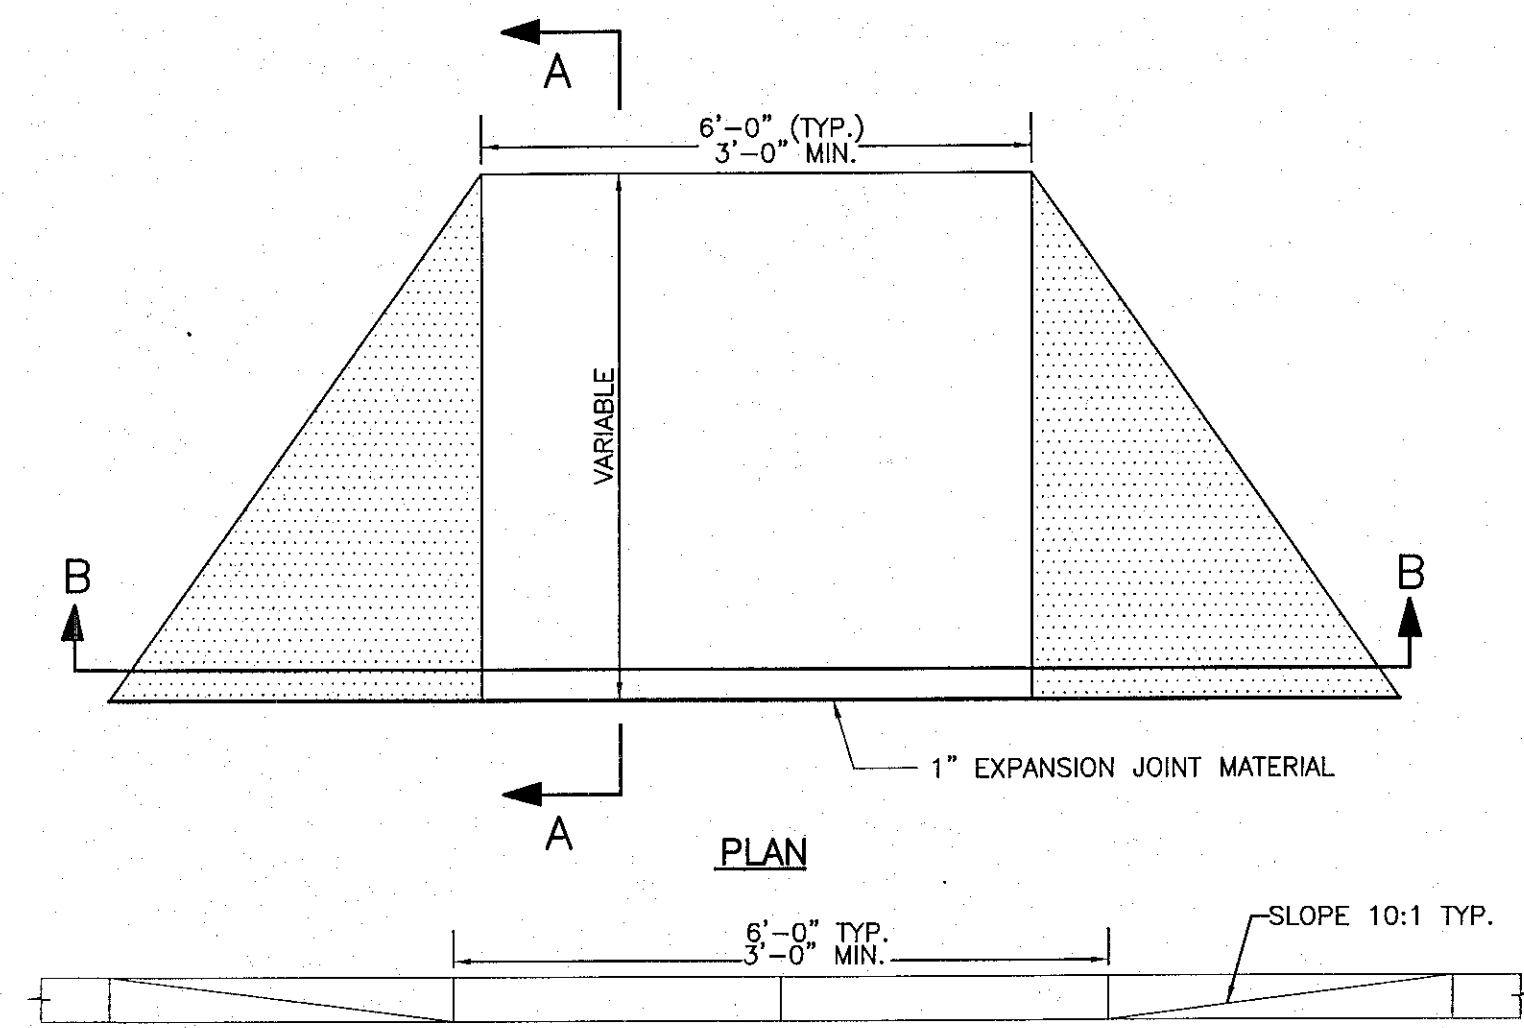


SECTION B-B

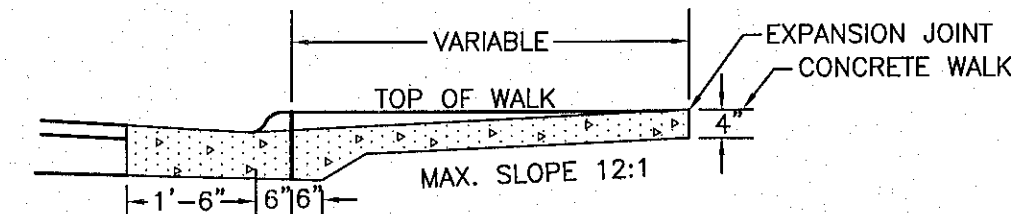


SECTION A-A
WHEELCHAIR RAMP
NO SCALE


- NOTES:
1. GEOTEXTILE SHALL BE CUT FROM A CONTINUOUS ROLL TO ELIMINATE JOINTS. IF ANY JOINTS ARE NECESSARY THEY WILL BE OVERLAPPED TO THE NEXT STAKE.
 2. STAKE MATERIAL WILL BE STANDARD 2"x4" WOOD OR EQUIVALENT METAL WITH A MINIMUM LENGTH OF 3 FEET.
 3. SPACE STAKES EVENLY AROUND INLET WITH A MAXIMUM SPACING OF 3 FEET. DRIVE STAKES 18" MINIMUM INTO GROUND. WIRE MESH MAY BE REQUIRED BEHIND GEOTEXTILE TO PROVIDE SUPPORT.
 4. GEOTEXTILE SHALL BE EMBEDDED 12" BELOW GROUND AND BACKFILLED. IT SHALL BE SECURELY FASTENED TO STAKES AND FRAME.
 5. A 2"x4" WOOD FRAME SHALL BE FORMED AROUND THE CREST OF FABRIC FOR OVERFLOW STABILITY.
 6. INLET PROTECTION TO REMAIN IN-PLACE UNTIL AREA IS STABILIZED.

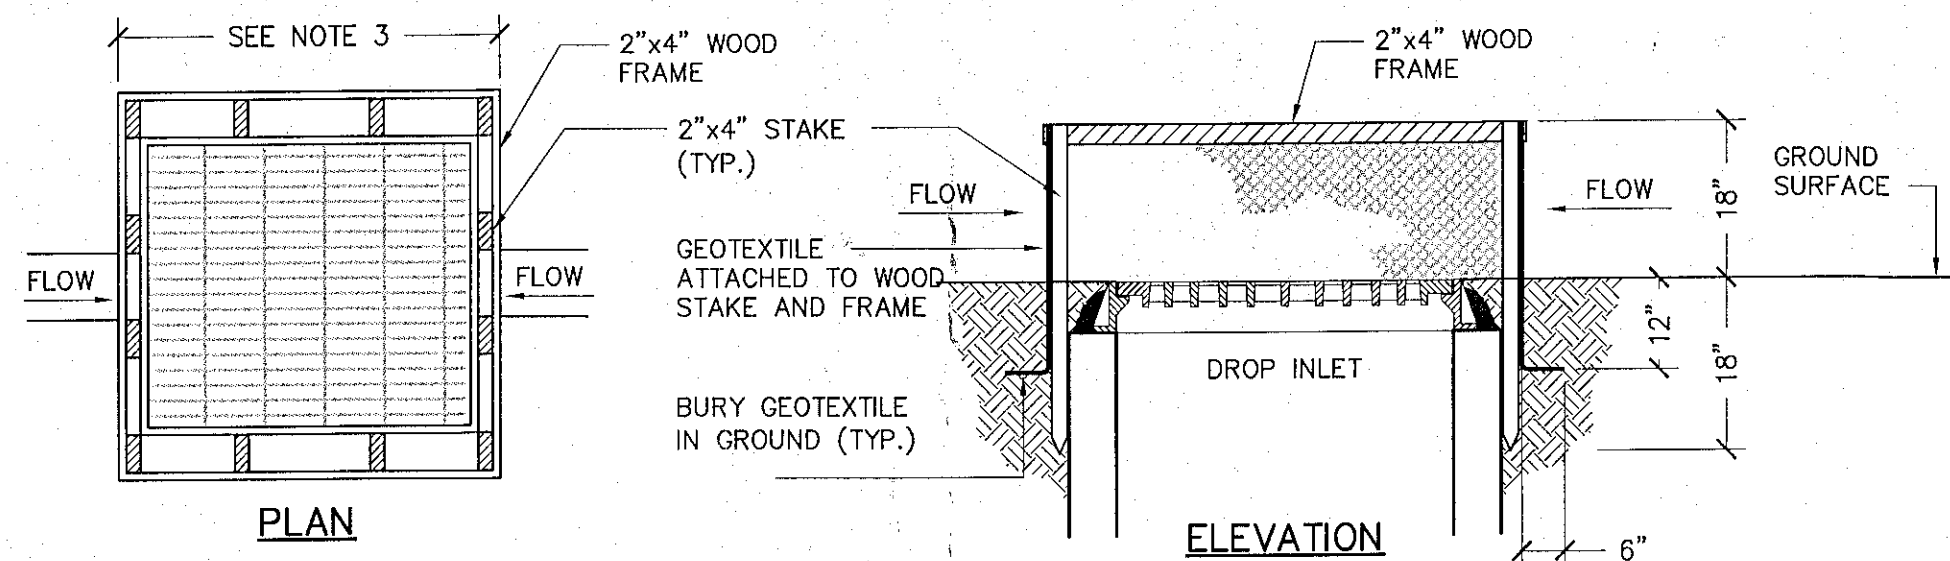

CATCH BASIN INLET PROTECTION
NOT TO SCALE

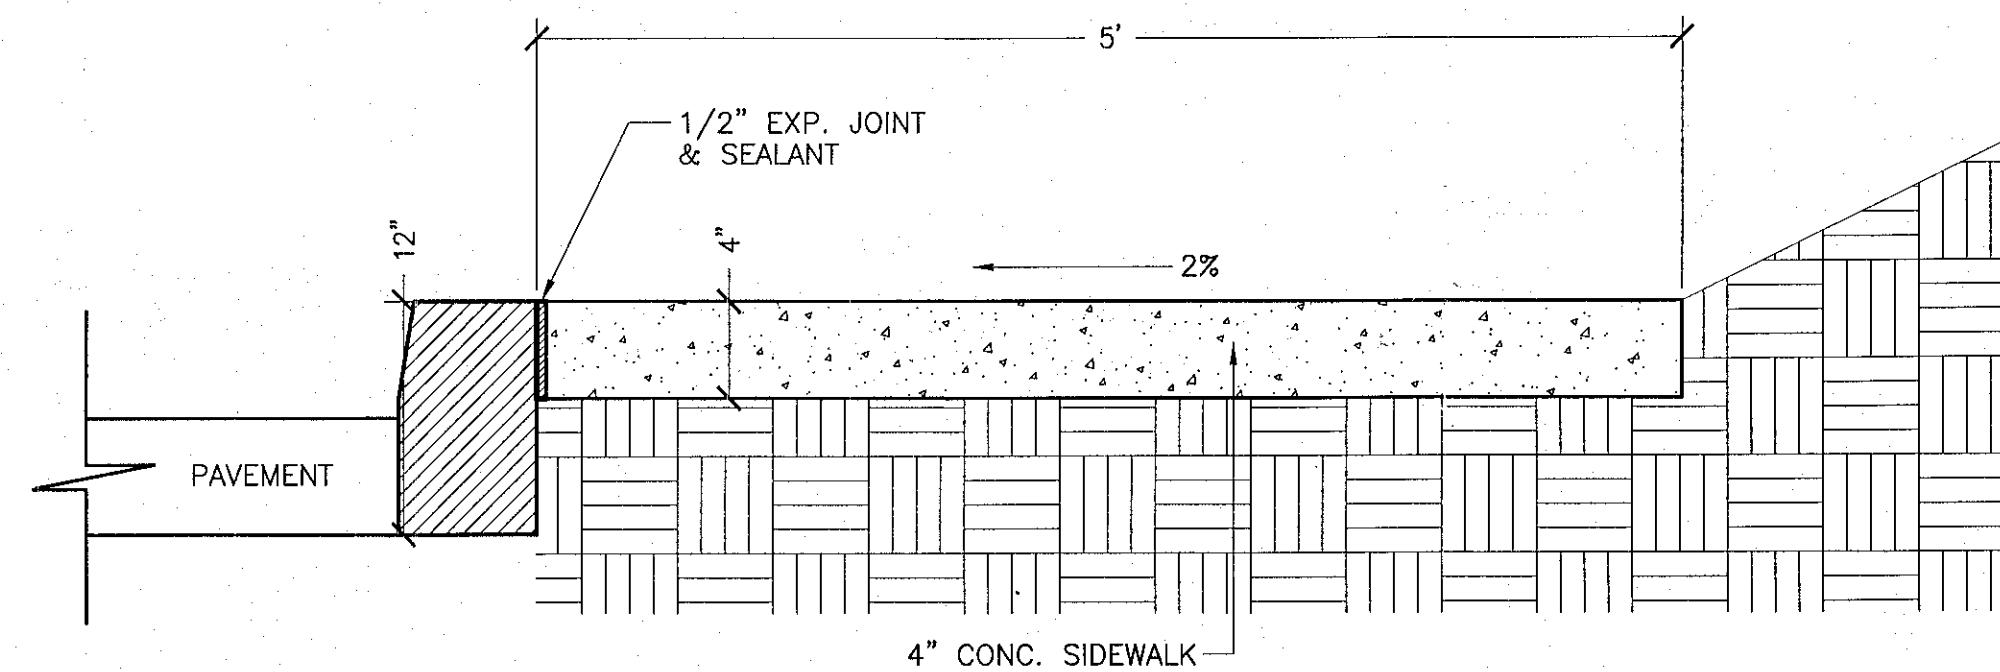


TYPICAL SIDEWALK CROSS-SECTION
NO SCALE

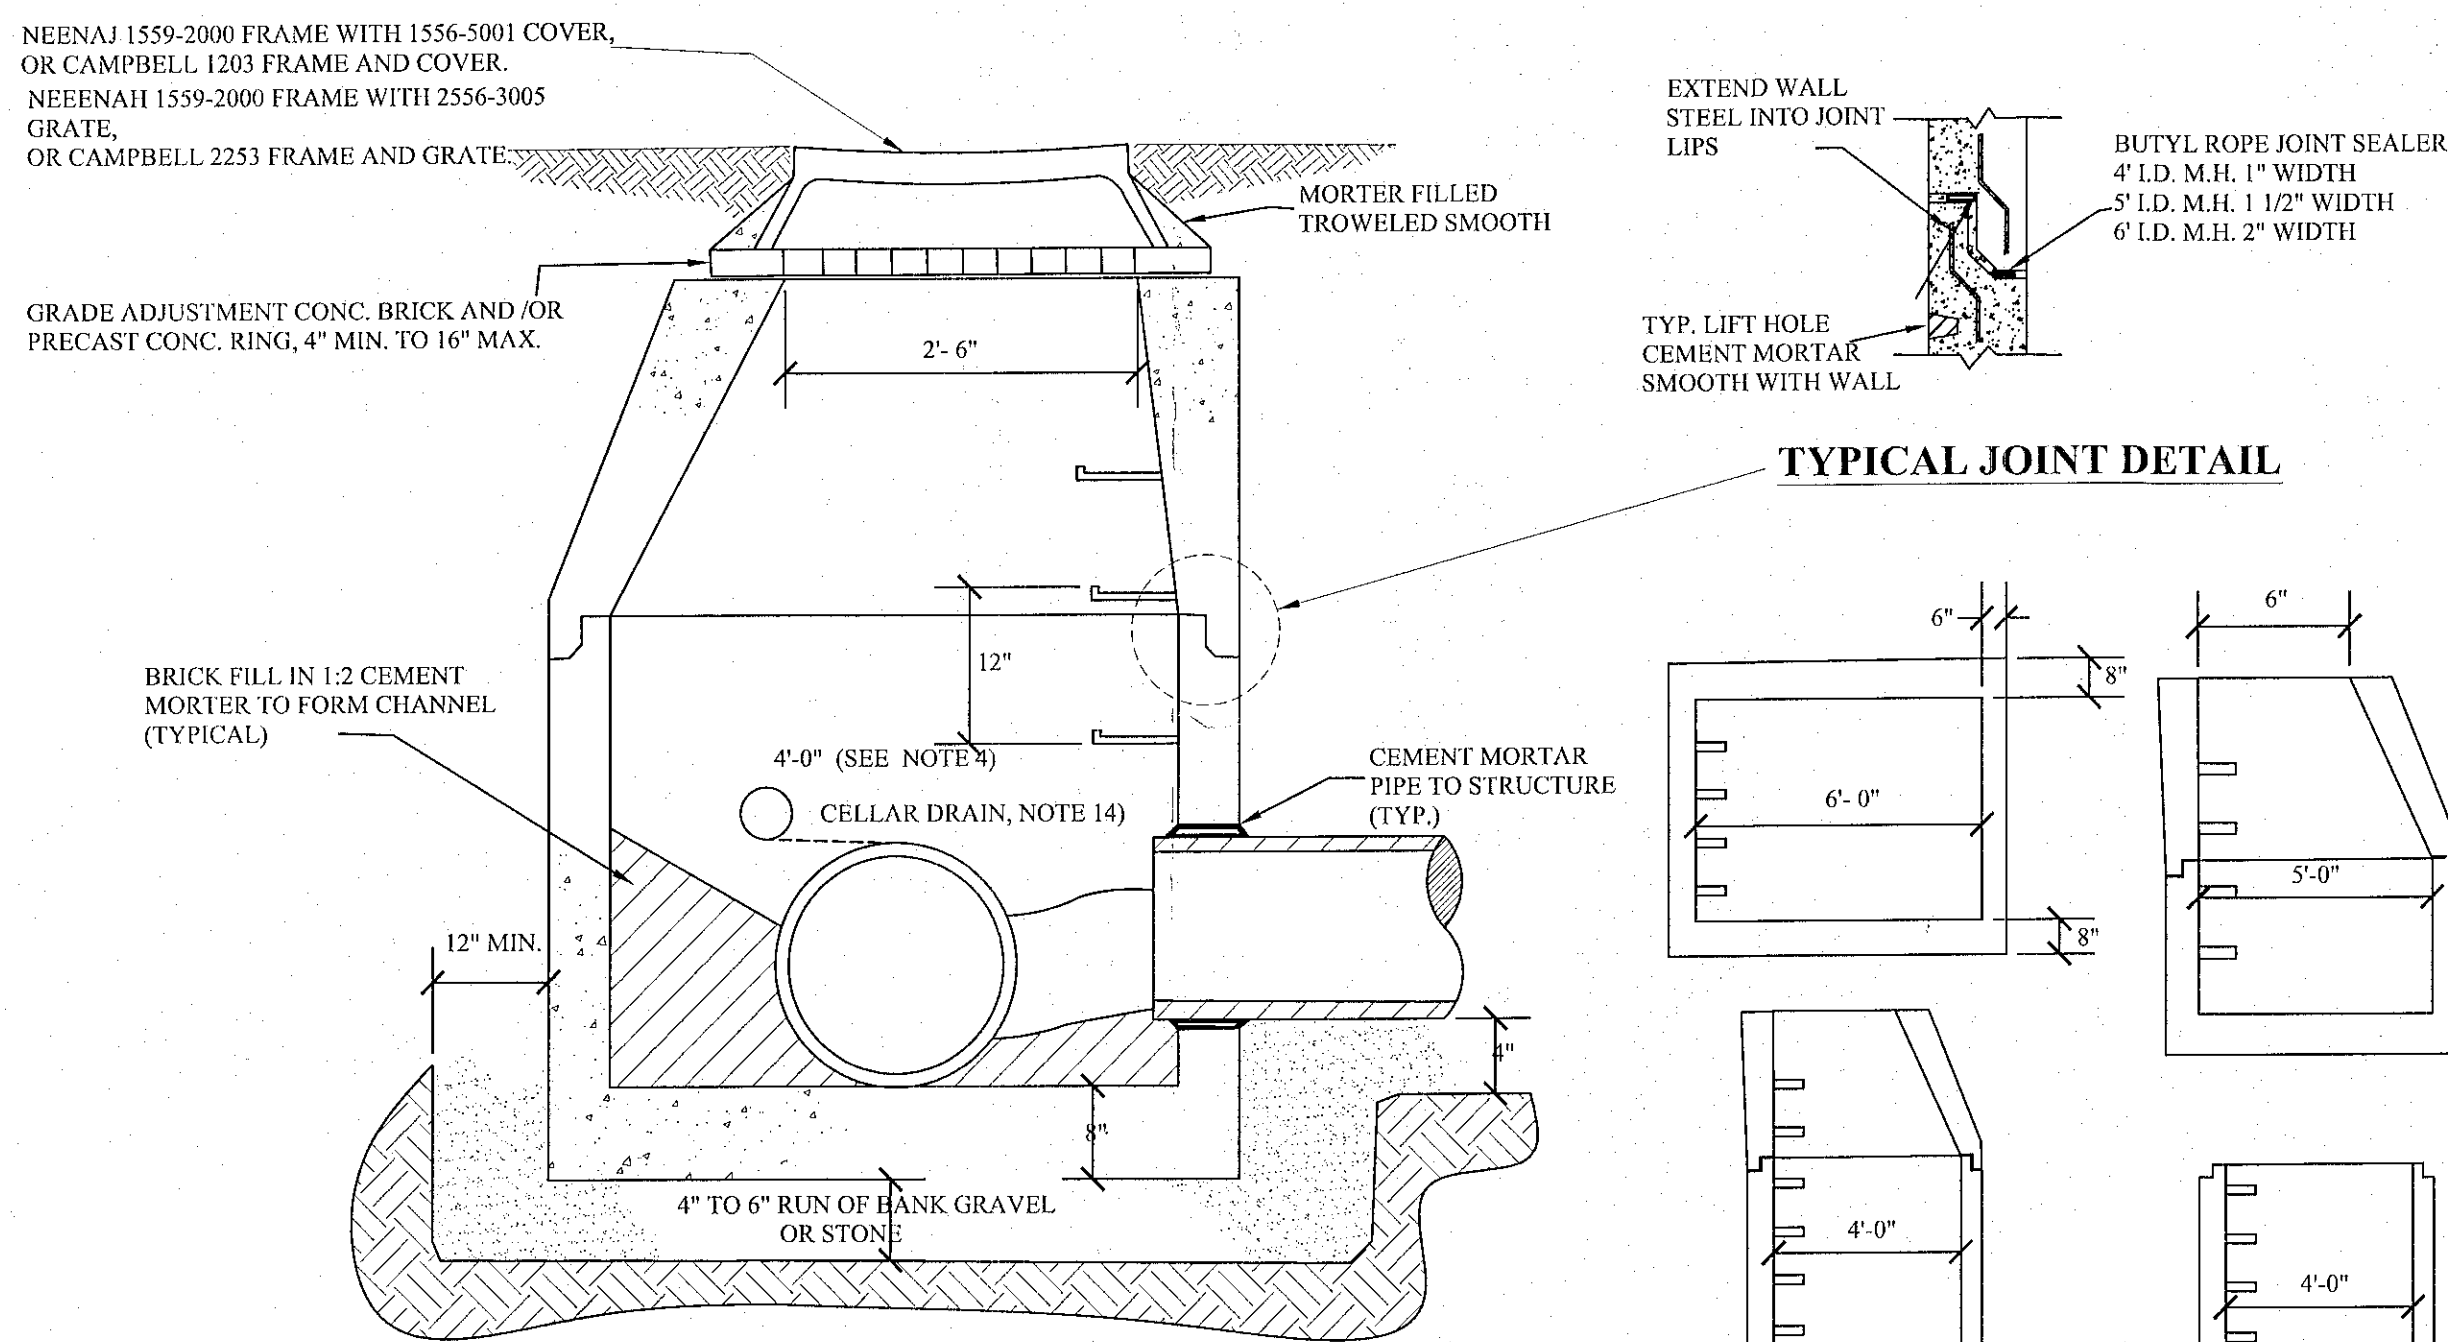


PRECAST CONCRETE TYPE
CATCH BASIN AND /OR MANHOLE DETAILS

TYPICAL PRECAST MANHOLES

STANDARD TOWN OF BETHLEHEM CATCH BASIN DETAIL
NO SCALE

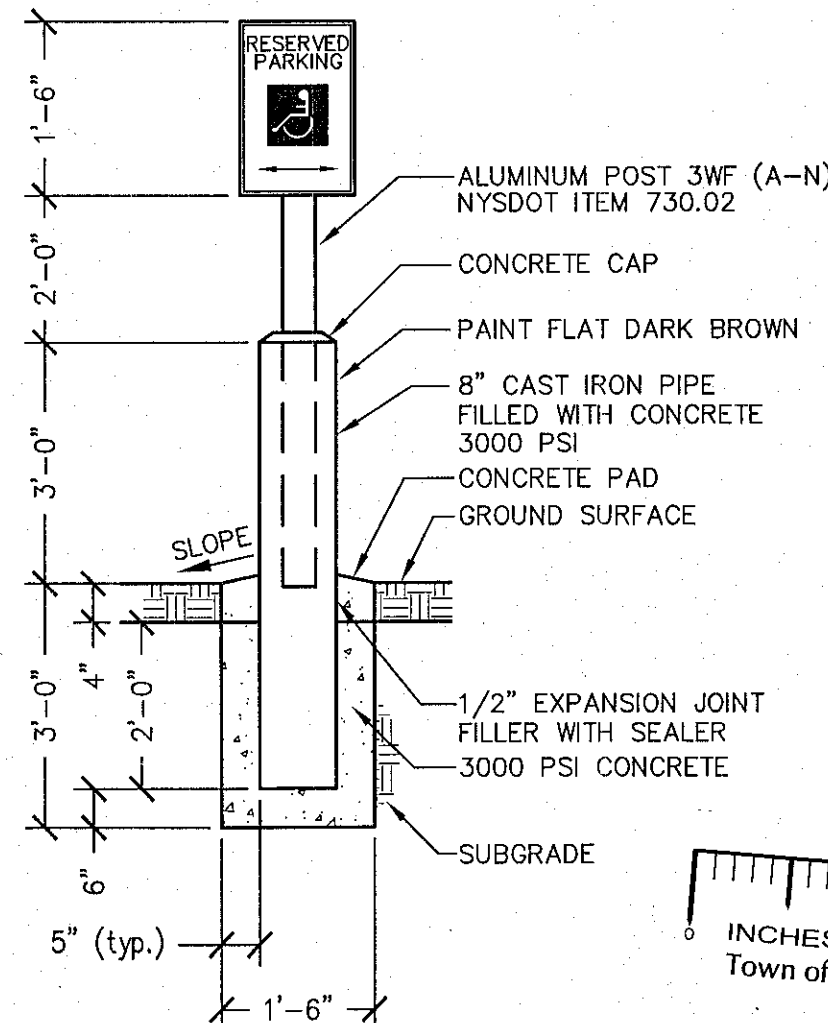


PIPE BOLLARD AND HANDICAP SIGN DETAIL
NO SCALE

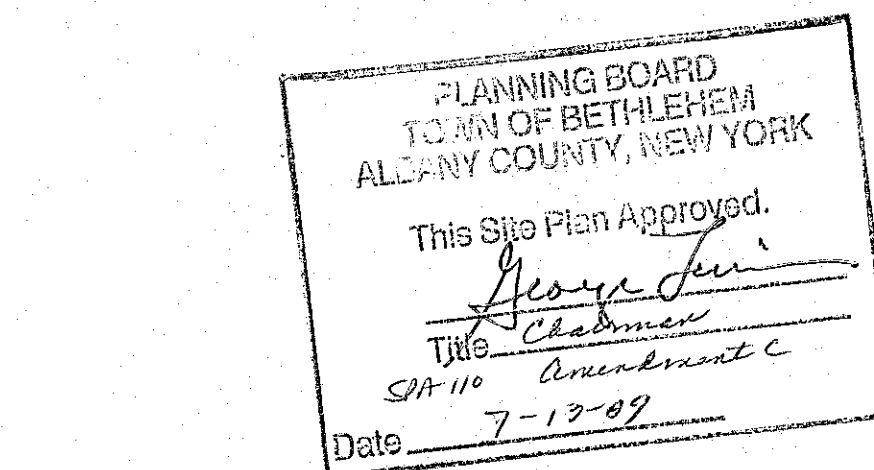


3" WIDE PAINTED LINES
2 COATS OF TRAFFIC PAINT COLOR TO MEET ADA REQUIREMENTS



HANDICAP SYMBOL
NO SCALE

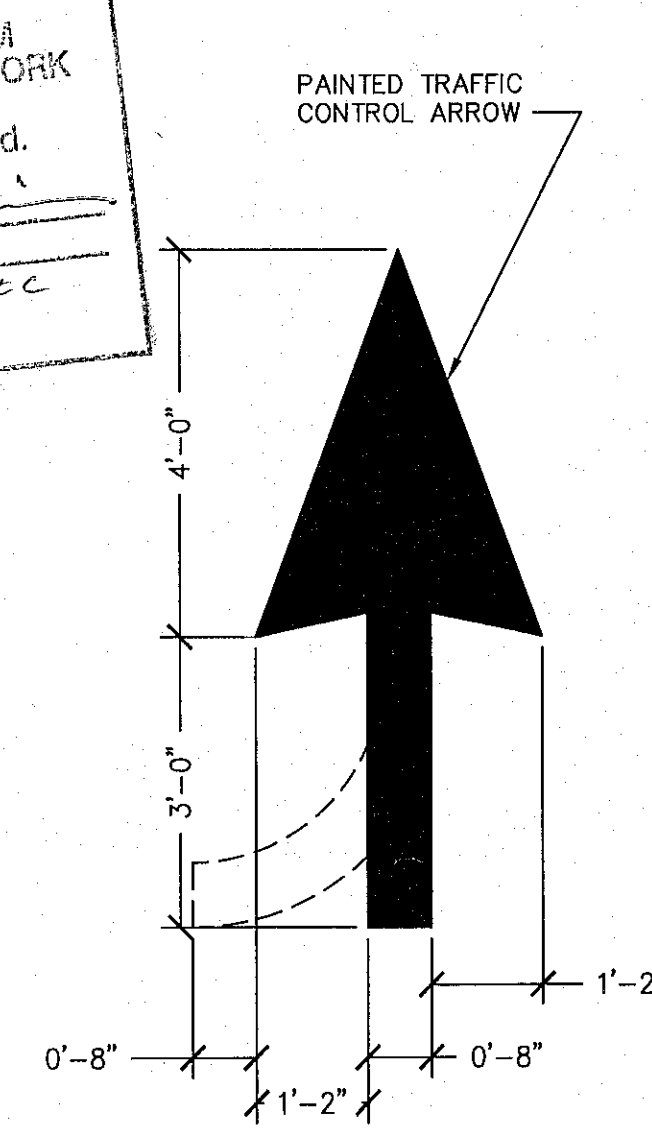


TRAFFIC ARROW
NO SCALE

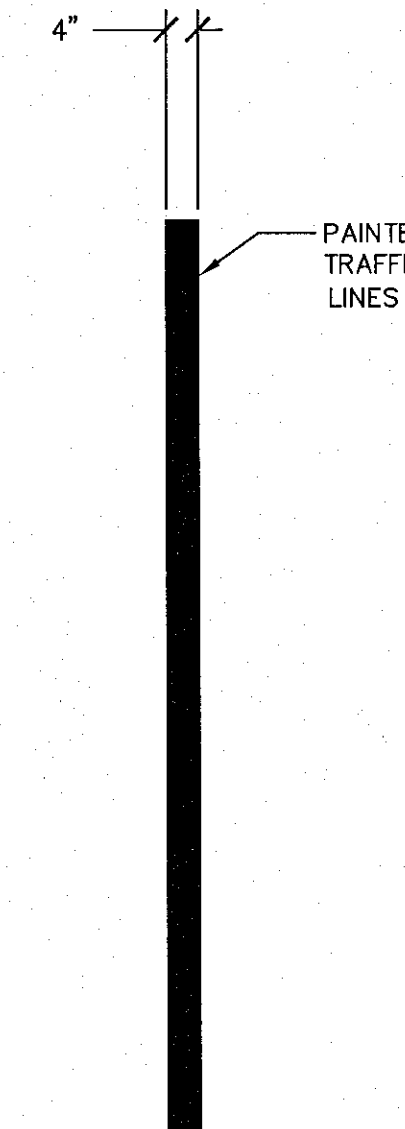

TRAFFIC LINE
NO SCALE

infinity
engineering
& surveying
11 Herbert Drive
Latham, New York 12110
(518) 690-0790

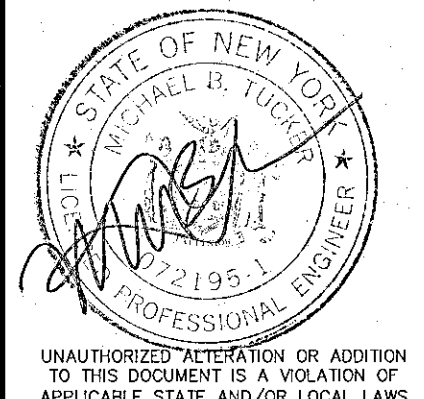

1	Revised Sidewalk Section	MBT	7/07/09
0			

No.	Submittal / Revision	App'd	Date

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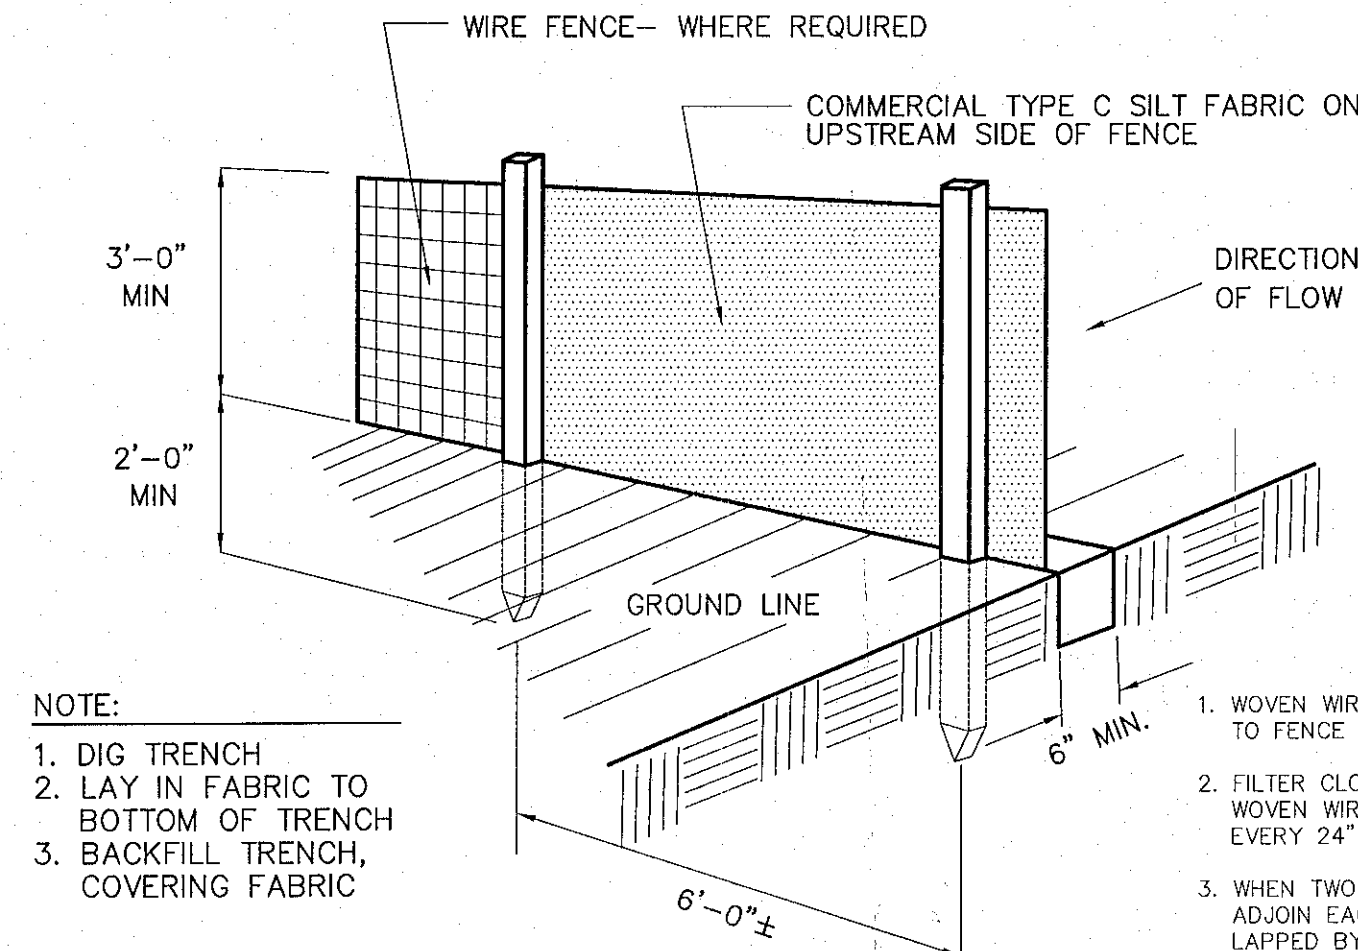
596 New Loudon Road
Latham, New York 12110



Drawing Title
Details

Drawing Scale:
Date:
06-22-2009

Drawing Number
C-5




- NOTE:
1. DIG TRENCH
 2. LAY IN FABRIC TO BOTTOM OF TRENCH
 3. BACKFILL TRENCH, COVERING FABRIC


SILT FENCE DETAIL
NO SCALE

CONSTRUCTION NOTES FOR FABRICATED SILT FENCE


1. WOVEN WIRE FENCE TO BE FASTENED SECURELY TO FENCE POSTS WITH WIRE TIES OR STAPLES.
 2. FILTER CLOTH TO BE FASTENED SECURELY TO WOVEN WIRE FENCE WITH TIES SPACED EVERY 24" AT TOP AND MID SECTION.
 3. WHEN TWO SECTIONS OF FILTER CLOTH ADJOIN EACH OTHER THEY SHALL BE OVERLAPPED BY SIX INCHES AND FOLDED.
 4. MAINTENANCE SHALL BE PERFORMED AS NEEDED AND MATERIAL REMOVED WHEN "BULGES" DEVELOP IN THE SILT FENCE.
 5. ALL SILT FENCE MATERIALS MUST BE LISTED ON THE CURRENT STATES. D.O.T. QUALIFIED PRODUCTS LIST.
- POSTS: STEEL EITHER T OR U TYPE.
- FENCE: WOVEN WIRE, 14 GA. 6" MAX. MESH OPENING.
- FILTER CLOTH: FILTER X, MIRAFI 100X STABLINKA T140N OR APPROVED EQUAL.
- PREFABRICATED UNIT: GEOFAB, ENVIROFENCE OR APPROVED EQUAL.

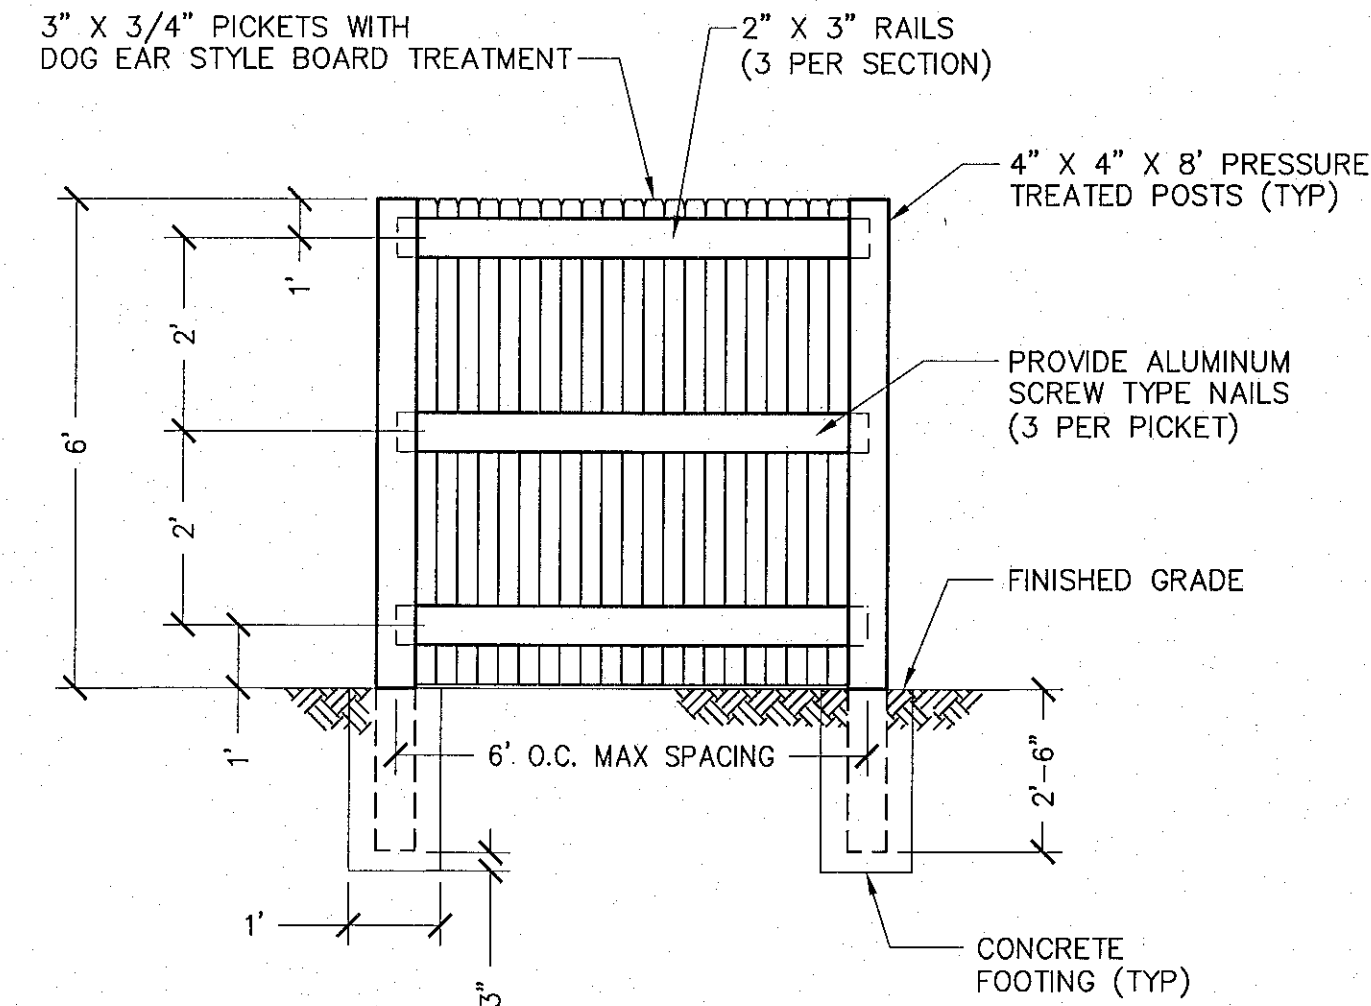

STOCKADE FENCE DETAIL (DOG EAR-STYLE)
NO SCALE

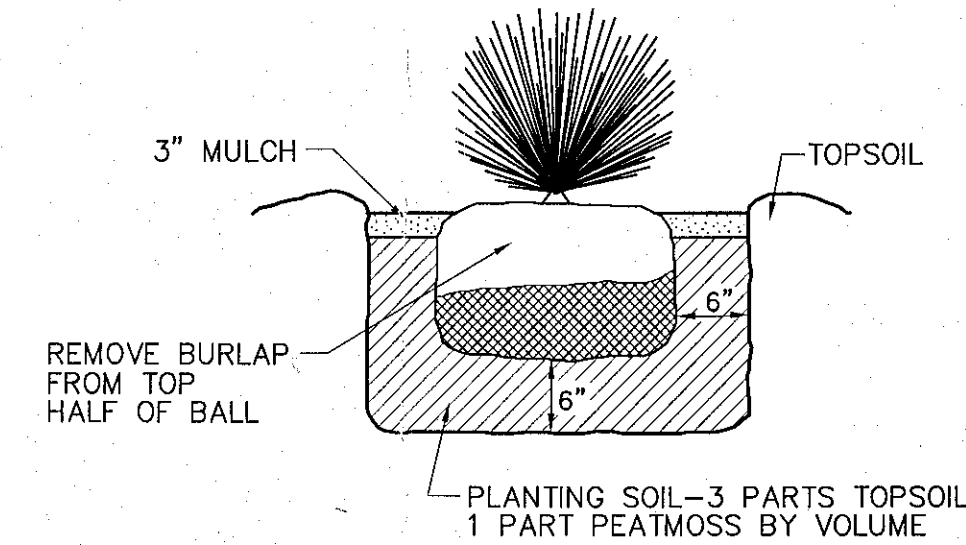

TYPICAL SHRUB PLANTING DETAIL
NO SCALE

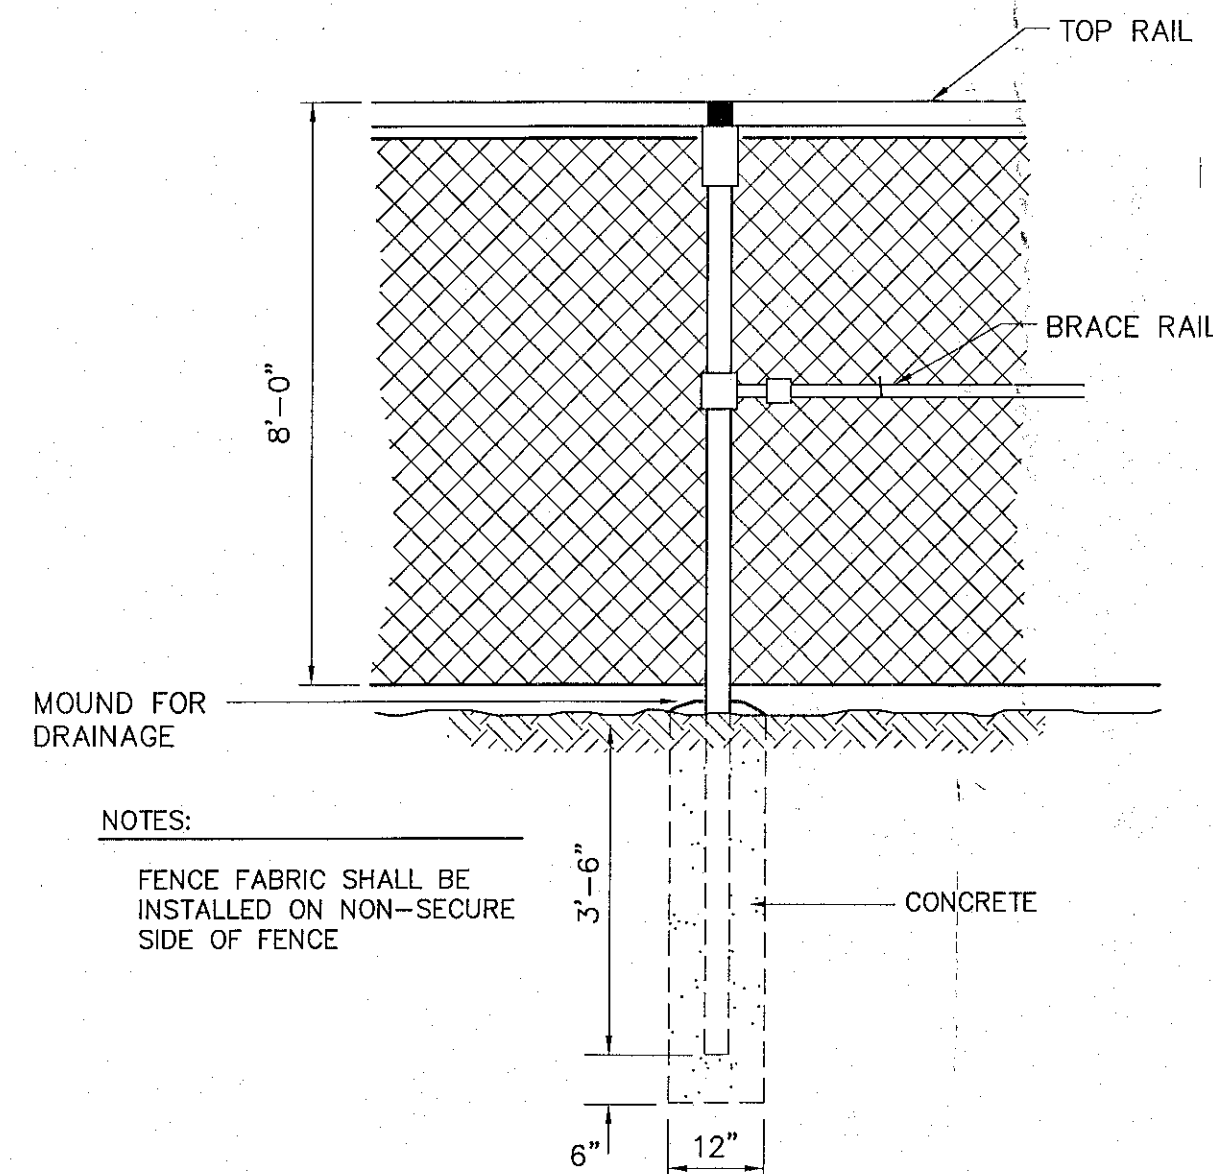


- NOTES:
- FENCE FABRIC SHALL BE INSTALLED ON NON-SECURE SIDE OF FENCE


CHAIN LINK FENCE
NO SCALE

NOTES:

1. FABRIC: 96" 9 GA. BLACK VINYL COATED (2" MESH) CHAIN LINK FABRIC
2. TOP & BOTTOM RAIL: 1 5/8" O.D. FULL WEIGHT PIPE, 2.28 LBS. PER FOOT MIN. TOP RAIL TO BE JOINED WITH 1 5/8" SLEEVE. BOTTOM RAIL @ 18" ABOVE GRADE.
3. LINE POST: 2 1/2" O.D. FULL WEIGHT PIPE, 3.65 LBS. PER FOOT MIN. LINE POST TO BE SET 10' ON CENTER MAX. SPACING. CONCRETE FOOTING TO BE 8" DIA. BY 30" DEEP CONCRETE.
4. TERMINAL POST: 3" O.D. FULL WEIGHT PIPE, 5.79 LBS. PER FOOT MIN. SET IN 8" DIA. BY 36" DEEP CONCRETE FOOTING.
5. GATE POST: 4" O.D. FULL WEIGHT PIPE, 9.10 LBS. PER FOOT MIN. 8" DIA., 36" DEEP CONCRETE FOOTING
6. GATES: (5) 2-10 FOOT CANTILEVERED VINYL COATED CHAIN LINK GATES, 2-20 FOOT SWING GATE WITH FRAMEWORK OF 1 5/8" FULL WEIGHT PIPE, 2.27 LBS. PER FOOT MIN. GATES BRACED AND TRUSSED AS NECESSARY. SAME FABRIC AS FENCE, SEE PLAN FOR WIDTH.
7. ROLLING GATES: DESIGN AS PER THE MANUFACTURERS DESIGN STANDARDS. GATES SHALL BE MANUALLY OPERATED ROLLING CANTILEVERED WITH RUBBER WHEELS AT FRONT OF GATE, AND BUMPER STOPS AT GATE ENDS, ROLLERS TO BE NYLON.
8. TENSION WIRE: 7 GA. COIL SPRING GALVANIZED TENSION WIRE ATTACHED TO BOTTOM OF FENCE FABRIC WITH 9 GA. ALUM. HOG RING SPACED 24" O.C.
9. FITTINGS: HEAVY BRACED BAND AND CARRIAGE BOLT, PRESSED STEEL, RAIL END, PRESSED STEEL, LOOP CAP, PRESSED STEEL CAP, 1/4"x3/4" TENSION BAR, HEAVY TENSION BAND AND CARRIAGE BOLT.
10. TIE WIRE: 8 1/4" 12 GA. STEEL TIE WIRE AND 6 1/2" 12 GA. STEEL WIRE SPACED 15" O.C. FOR LINE POST AND 24" O.C. FOR RAILS.
11. POST FOOTING: TRUCK POURED CONCRETE.

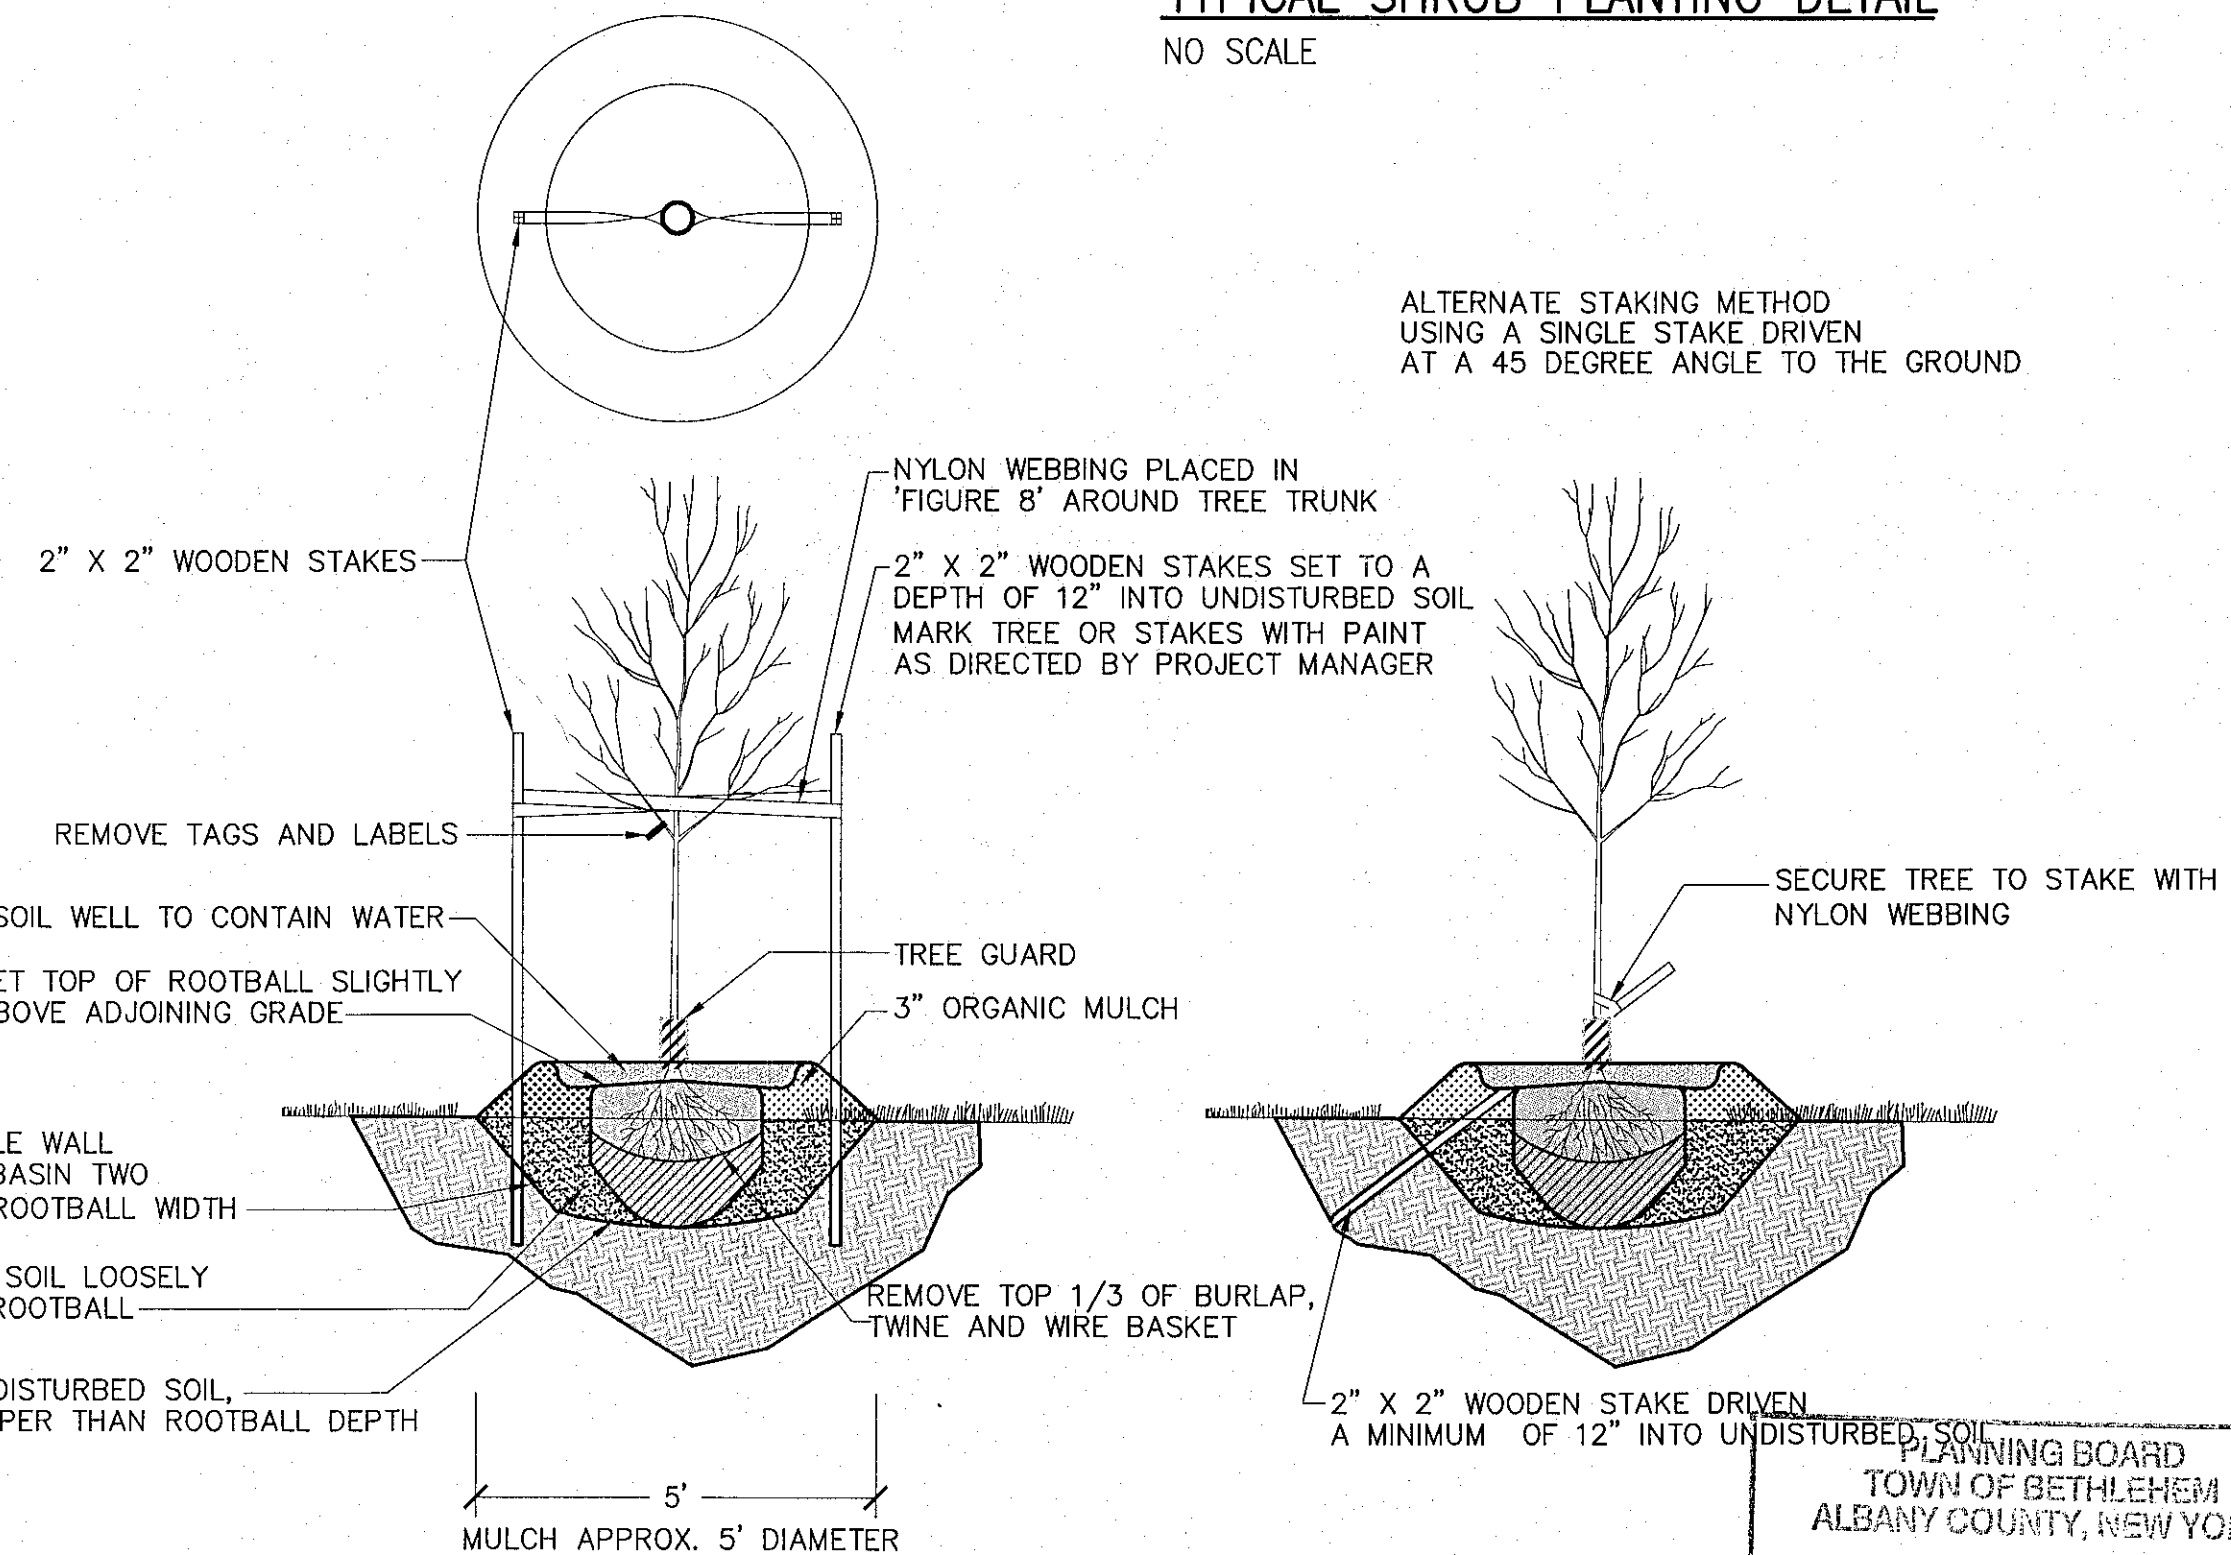

PLAN OF TYPICAL TREE PLANTING INSTALLATIONS
NO SCALE

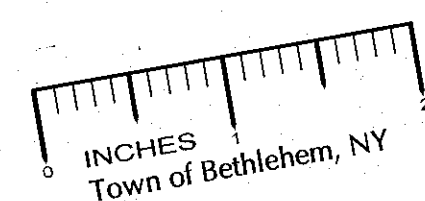


PLANNING BOARD
TOWN OF BETHLEHEM
ALBANY COUNTY, NEW YORK

This Site Plan Approved.

George J. ...
Title: *Chairman*
Date: *7-13-09*

infinity
engineering & surveying
11 Herbert Drive
Latham, New York 12110
(518) 690-0790

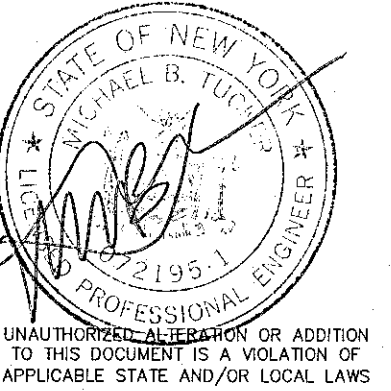

No.	Submittal / Revision	App'd	Date
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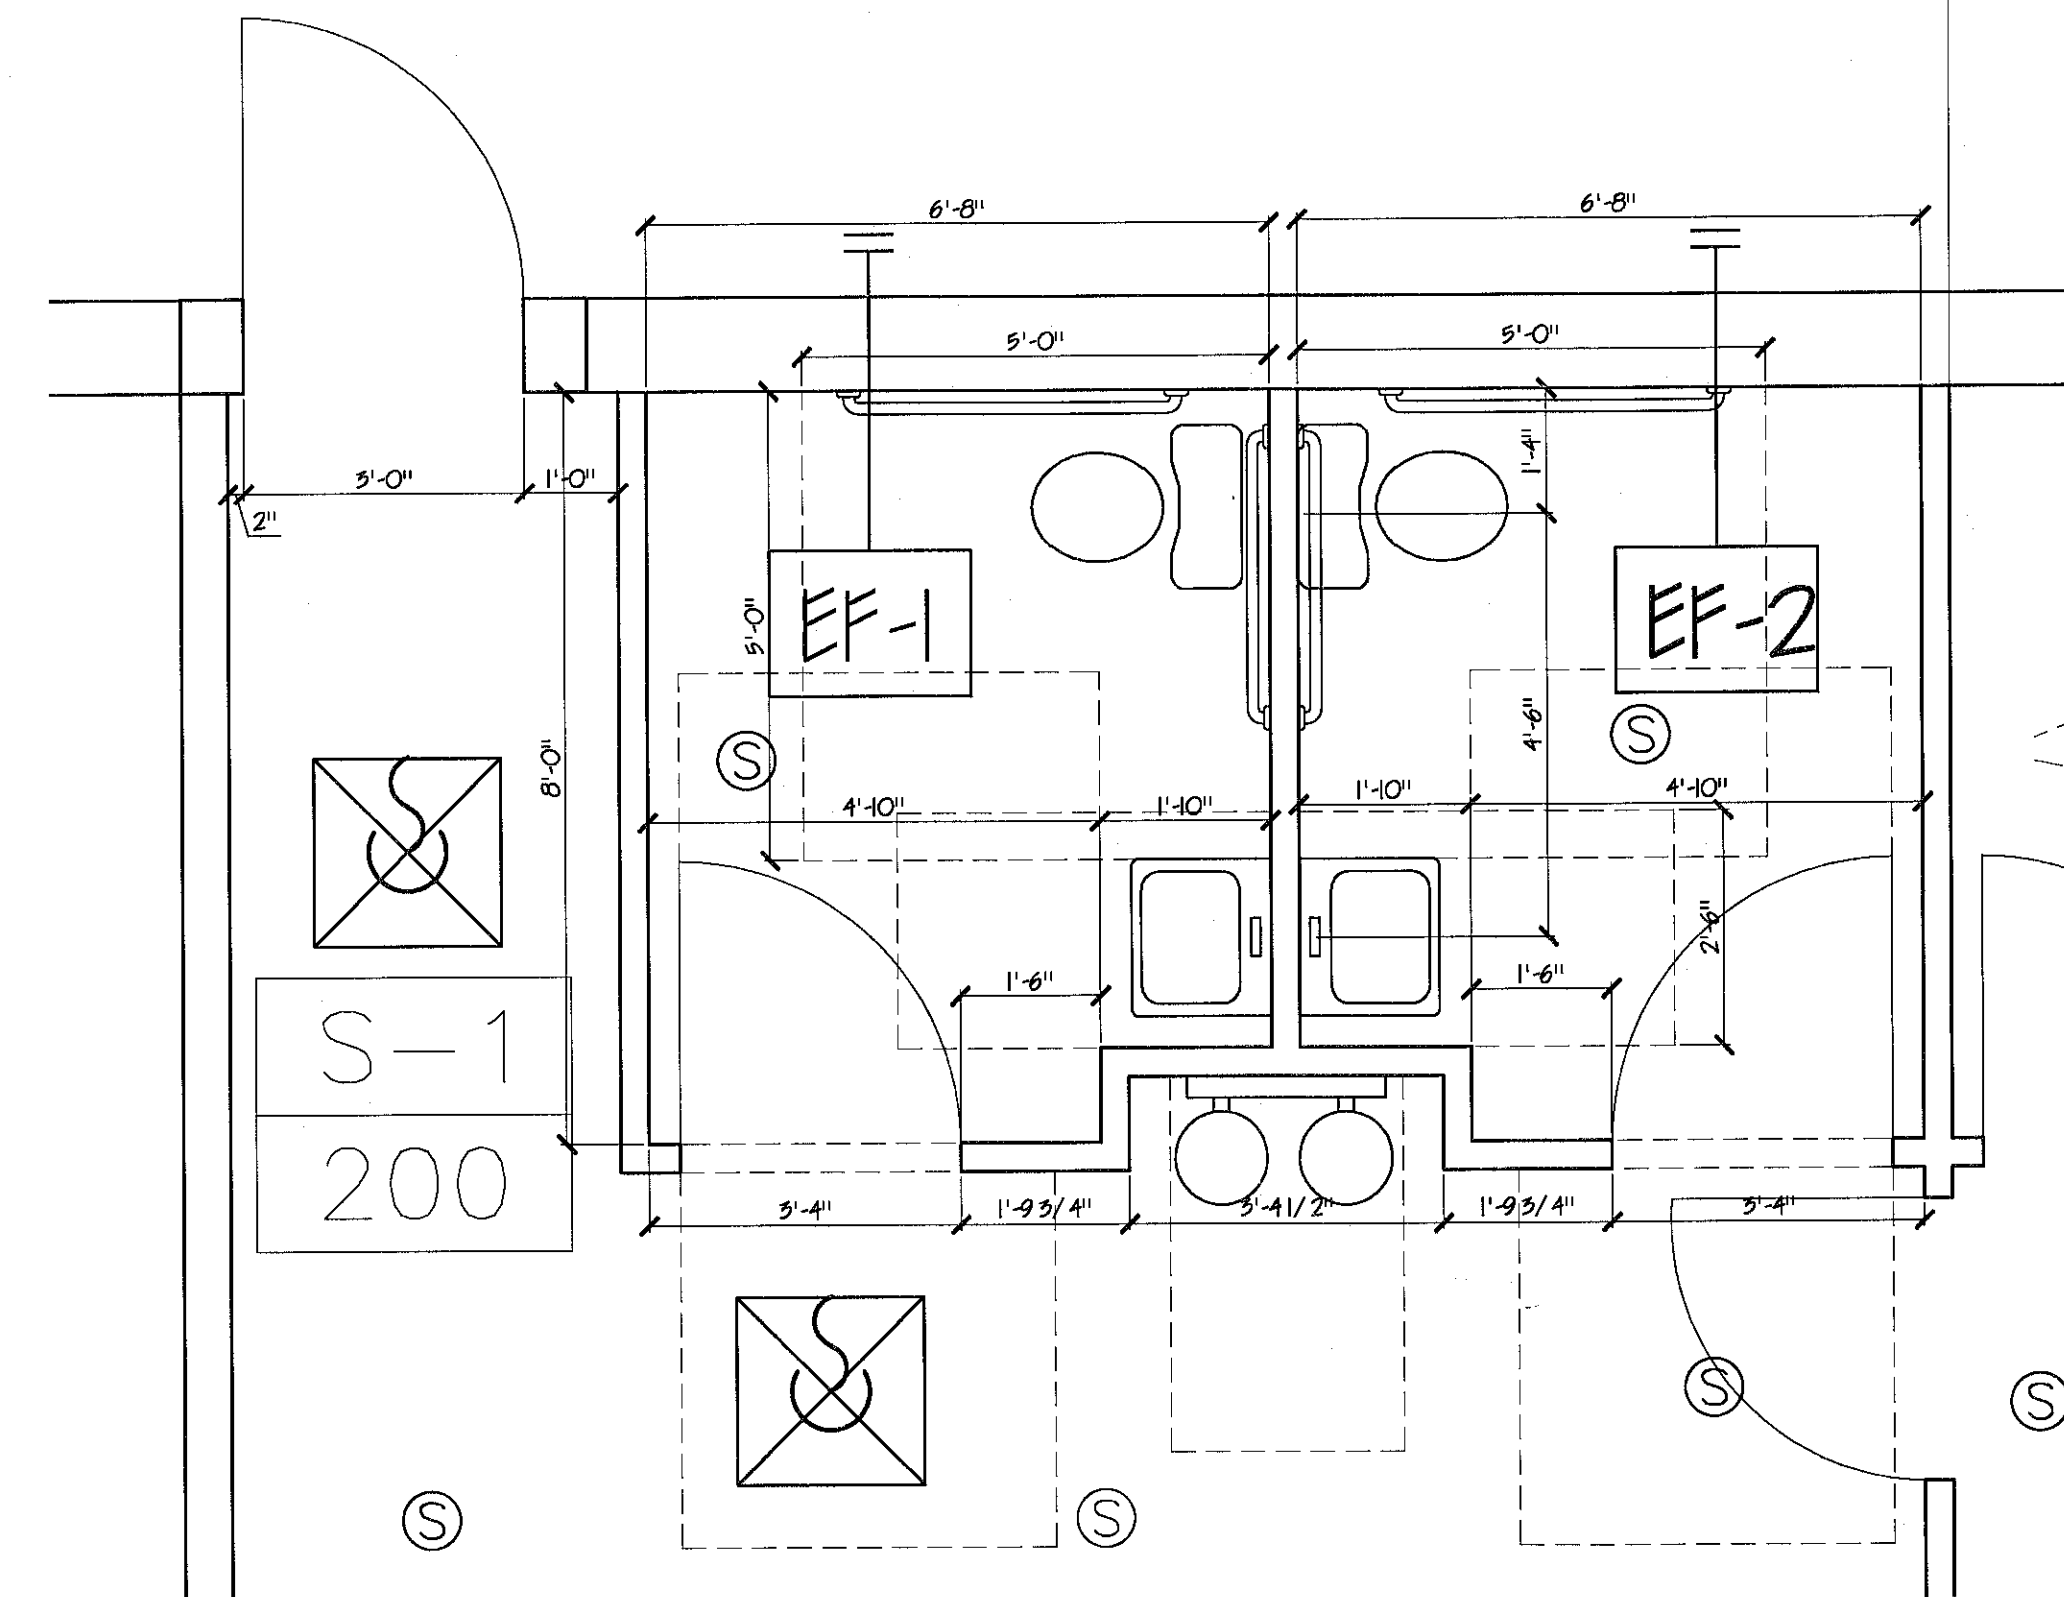
Drawing Title

Details


Drawing Scale: -
Date: 06-22-2009

Drawing Number


C-6




1 ENLARGED TOILET PLAN
1/2" = 1'-0"

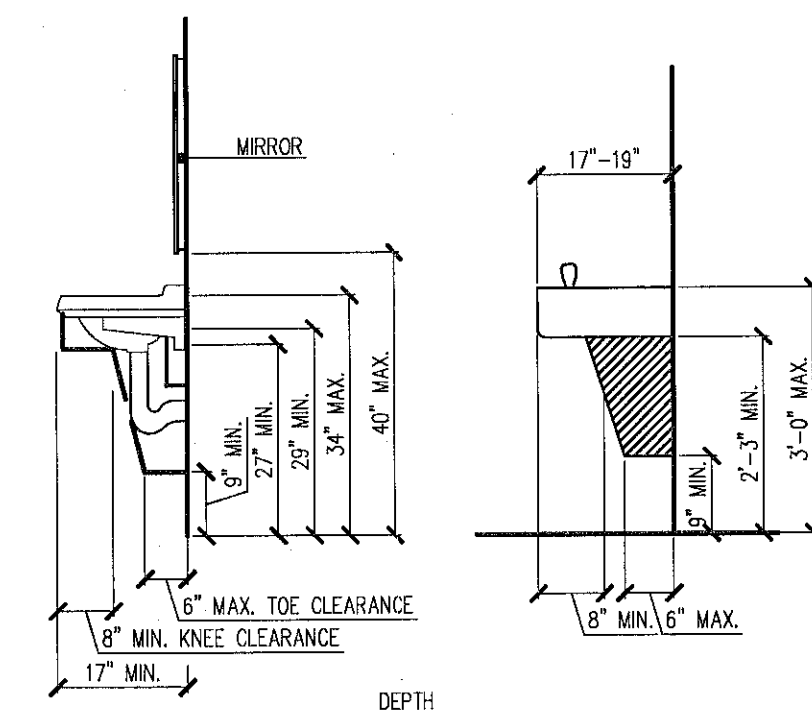


3 SINK AND WATER COOLER SECTION
N.T.S.

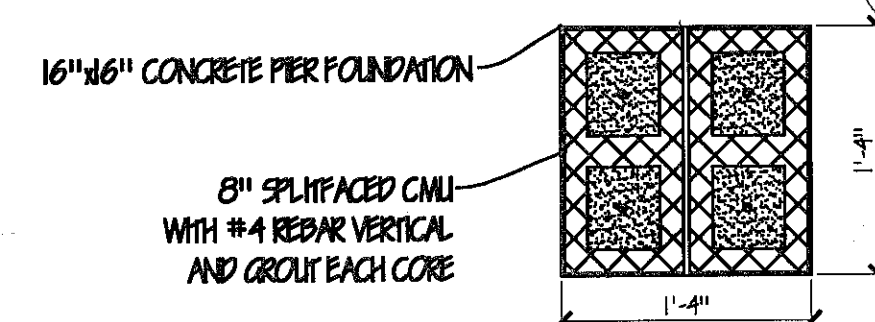

7 CONCRETE PIER DETAIL
N.T.S.

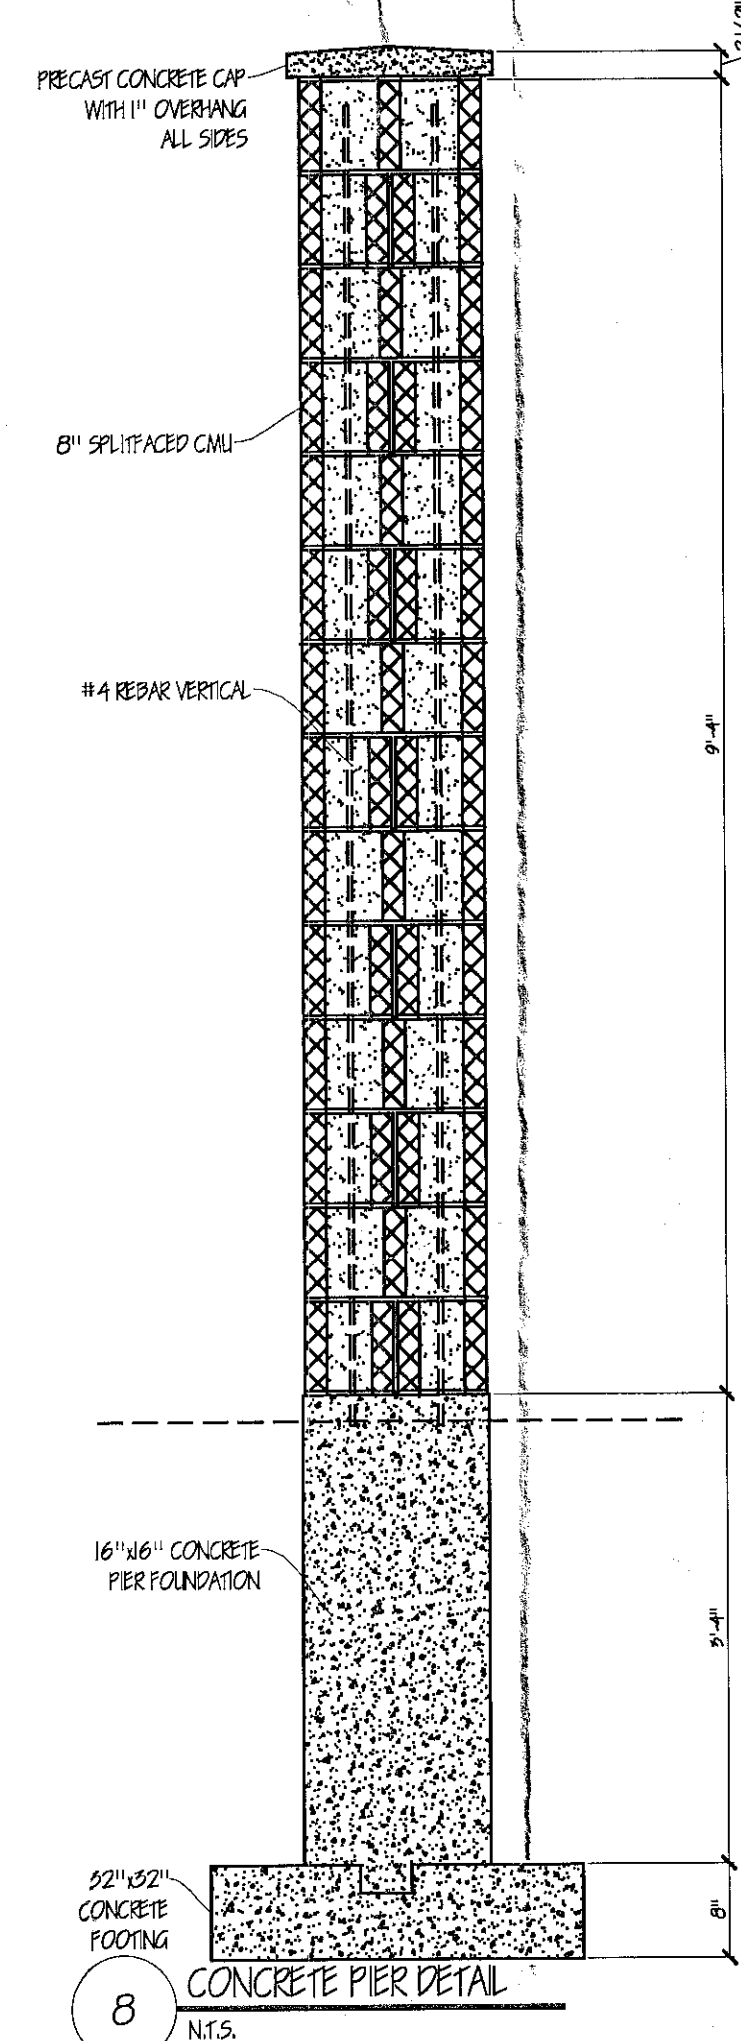


8 CONCRETE PIER DETAIL
N.T.S.

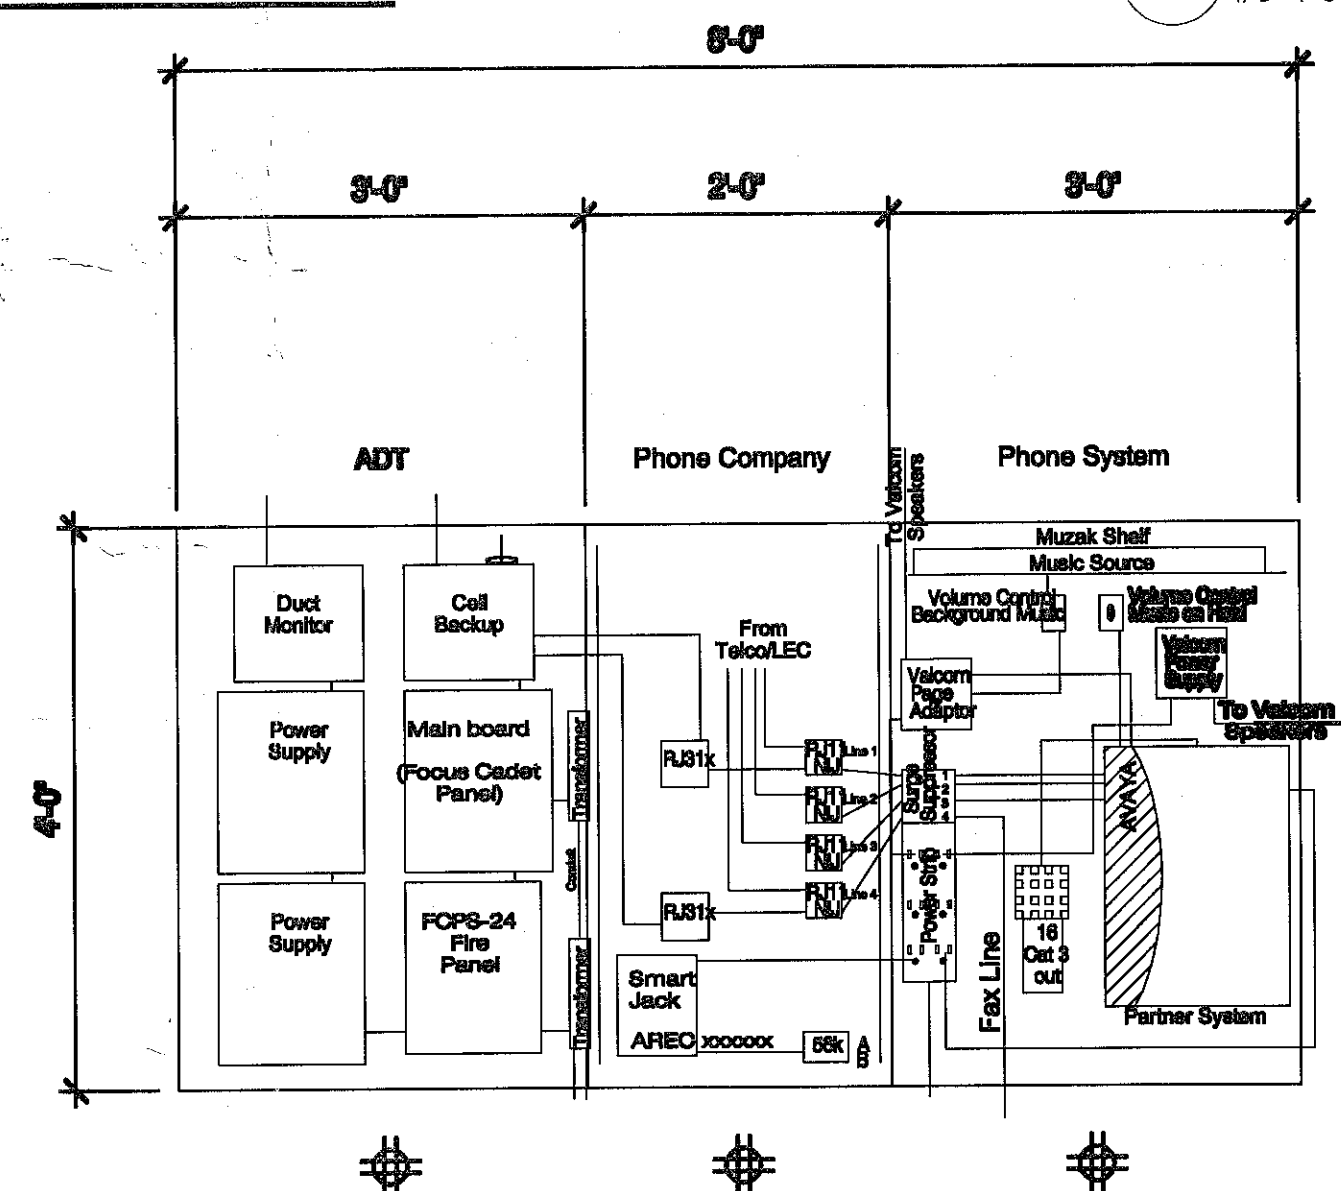

4 x 8 plywood phone board (Always Horizontal)

8 PHONE BOARD
N.T.S.

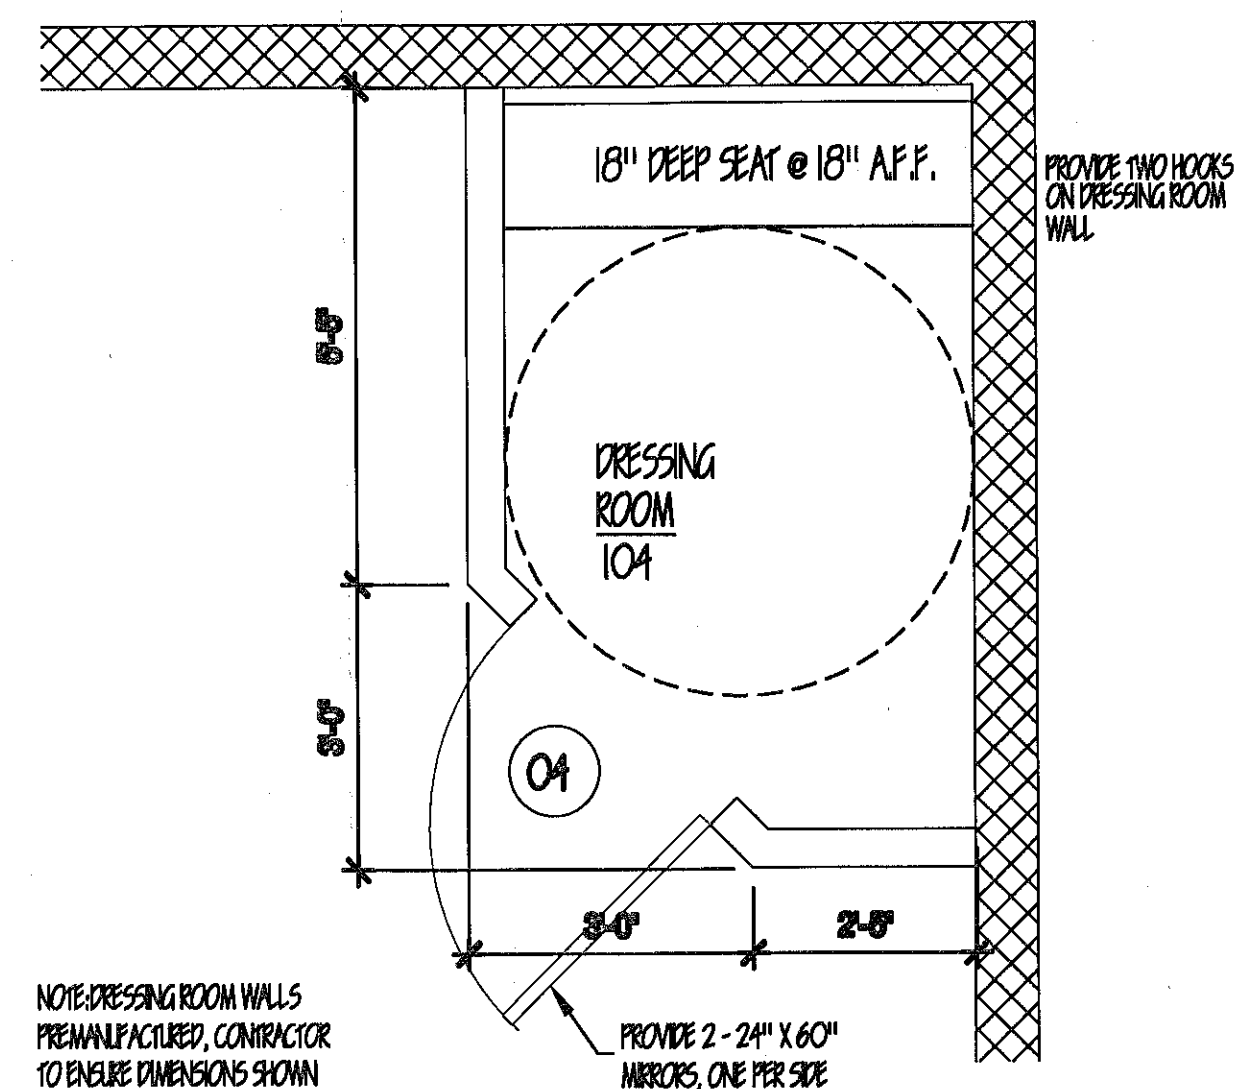


7 ENLARGED DRESSING ROOM PLAN
1/2" = 1'-0"

200 Powell Place
Brentwood, Tennessee 37027
615.366.4208

CAPITAL ARCHITECTURE
2390 WESTERN AVENUE
GUILDERLAND, NEW YORK 12084
518 867 4247 OFFICE
518 861 7040 FAX
518 253 1442 CELL

THIS WORK WAS PREPARED BY ME
OR UNDER MY SUPERVISION AND
CONSTRUCTION OF THIS PROJECT
WILL BE UNDER MY OBSERVATION.

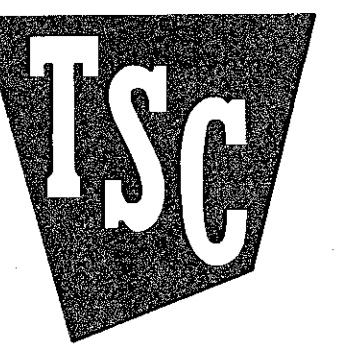

TRACTOR SUPPLY COMPANY

TRACTOR SUPPLY

3329 GLENMONT ROAD
GLENMONT, NY

DETAILS

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Job Number: _____

Date: 1 JULY 09

Revisions: 7 JULY 09

Drawn By: _____

Checked By: _____

A6

Sheet Number:

PLANNING BOARD
TOWN OF BETHLEHEM
ALBANY COUNTY, NEW YORK

This Site Plan Approved.

George J. ...

Title *Commercial*

504110 Commercial C

Date *7-13-09*

0 INCHES 1
Town of Bethlehem, NY