



CONCRETE PAVEMENT (PEDESTRIAN)  
SCALE: NOT TO SCALE

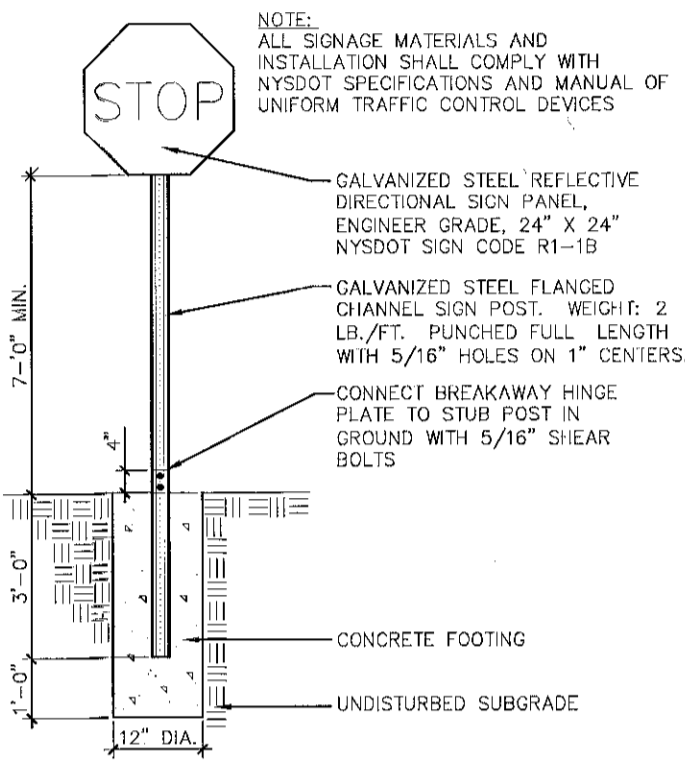


DIRECTIONAL SIGNAGE  
SCALE: NOT TO SCALE

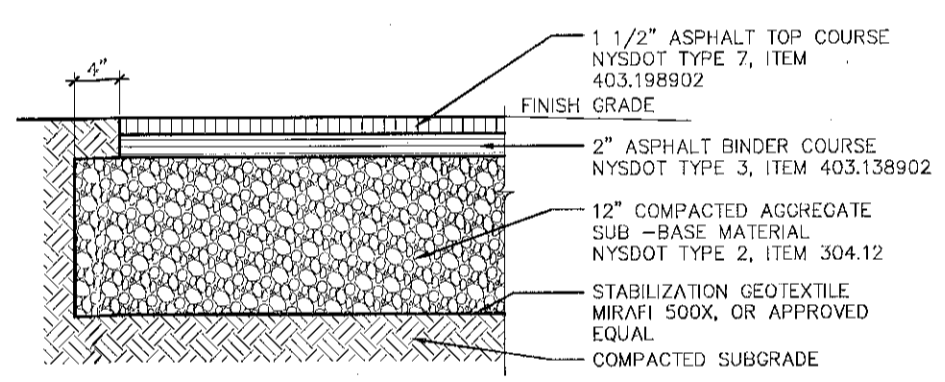


NOTES:  
1. AGGREGATE SUBBASE COMPACTED TO 95% STANDARD PROCTOR.  
2. CONTRACTOR SHALL PROVIDE DENSITY TESTING FROM AN INDEPENDENT TESTING LAB CONFORMING TO NYSDOT STANDARDS FOR ASPHALT AND SUBBASE COMPACTING.

LIGHT DUTY PAVEMENT  
SCALE: NOT TO SCALE



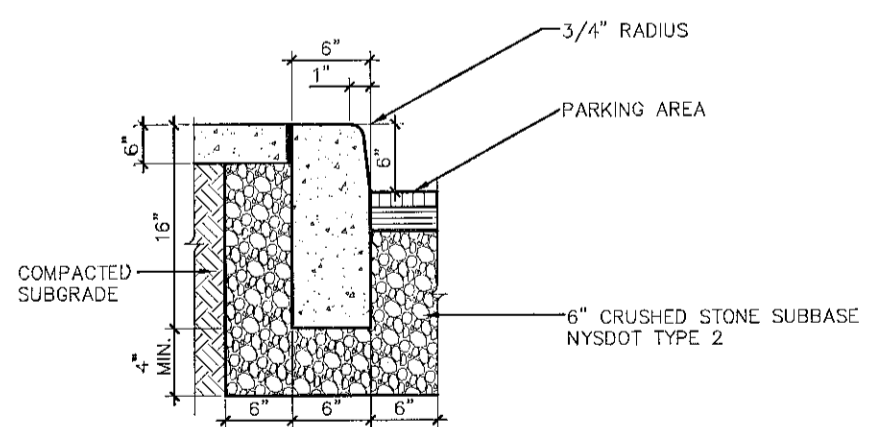


NOTES:  
1. CONTRACTION JOINTS TO FEET ON CENTER TO DEPTH OF 1/4 THE CURB THICKNESS.  
2. EXPANSION JOINTS WITH PREMOLDED FILLER 50 FEET TO CENTER.  
3. EXPOSED CONCRETE SURFACE TO HAVE A LIGHT BROOM FINISH.



CONCRETE CURB  
SCALE: NOT TO SCALE

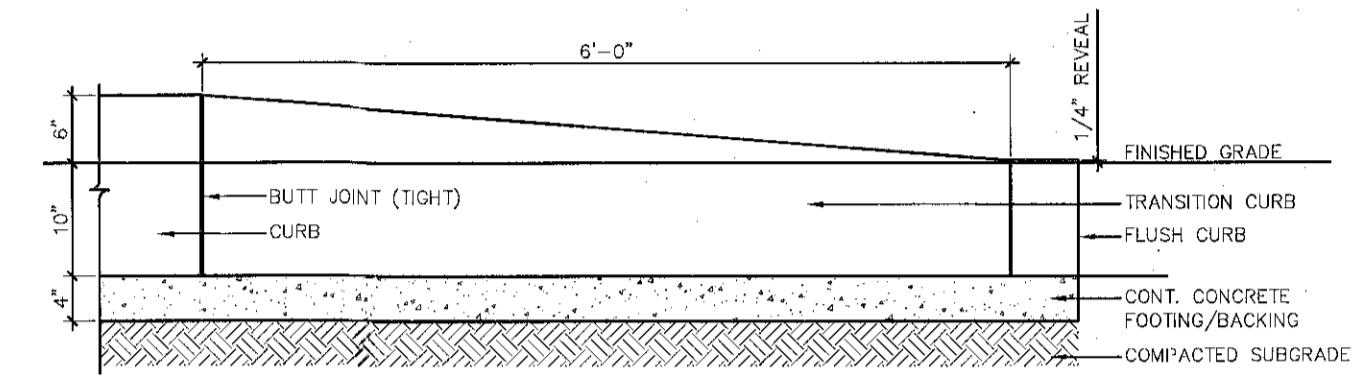

TRANSITION CURB  
SCALE: NOT TO SCALE

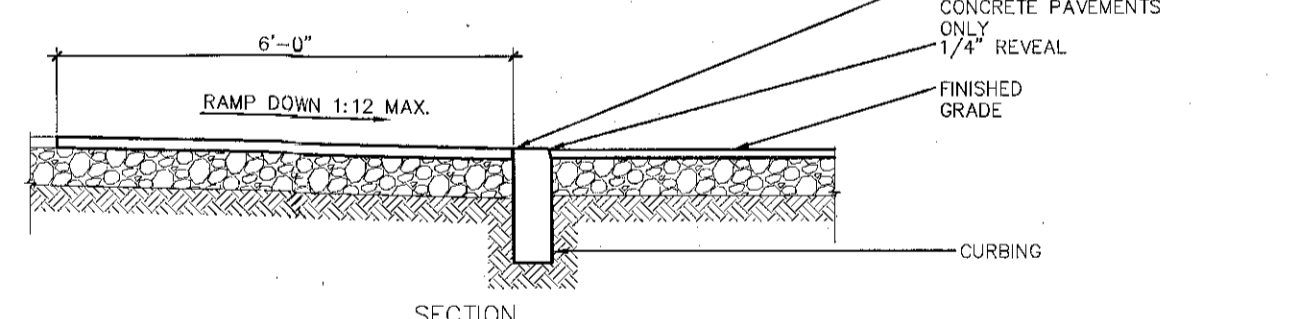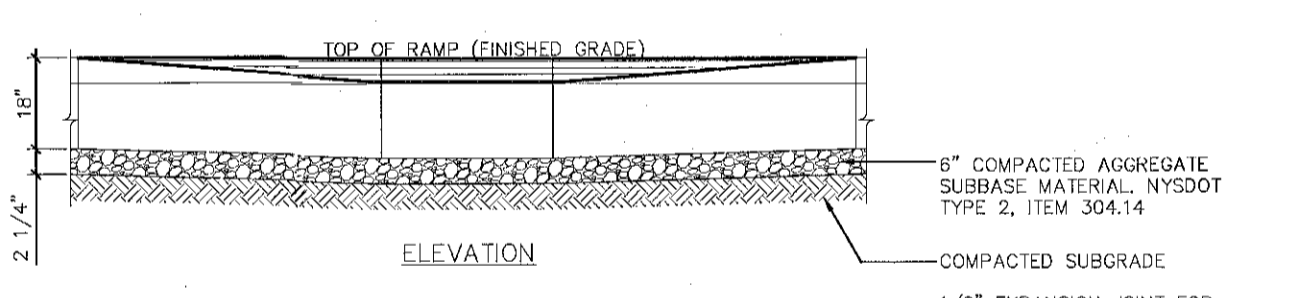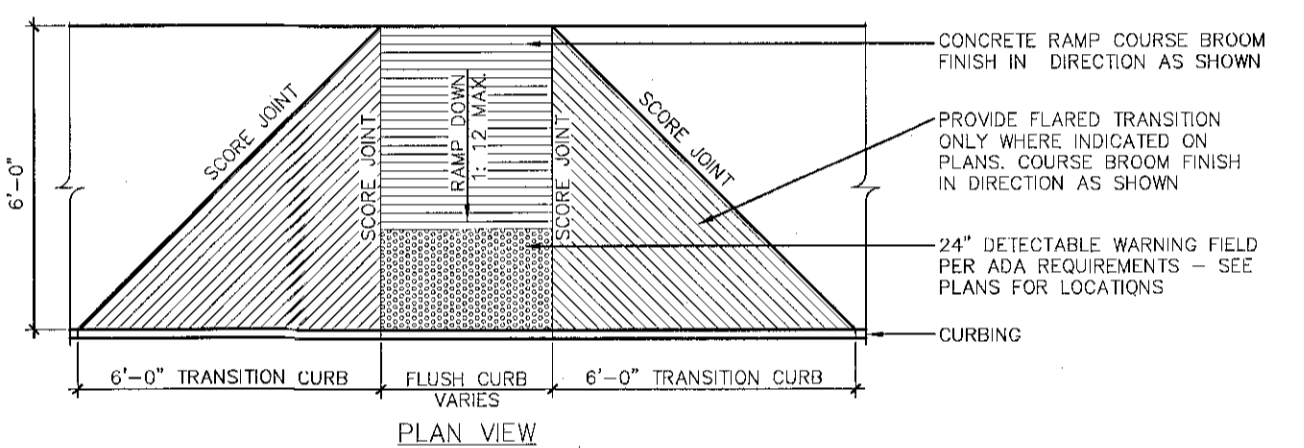


SIDEWALK RAMP  
SCALE: NOT TO SCALE

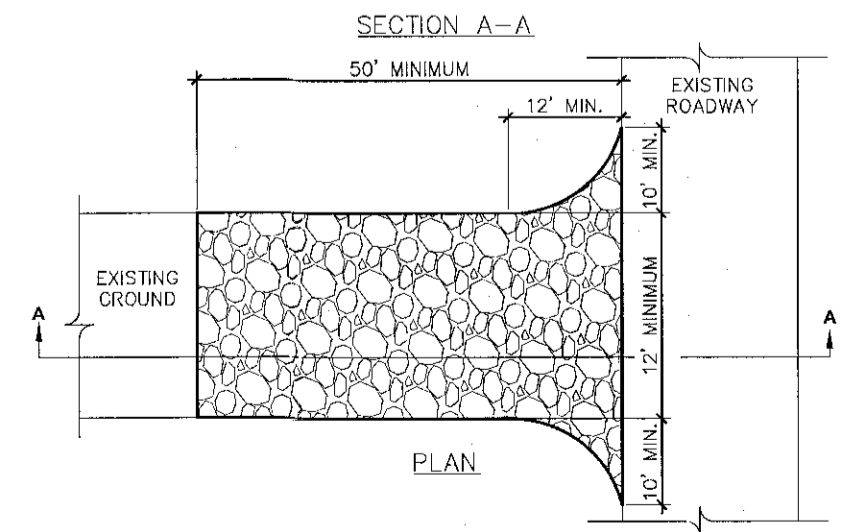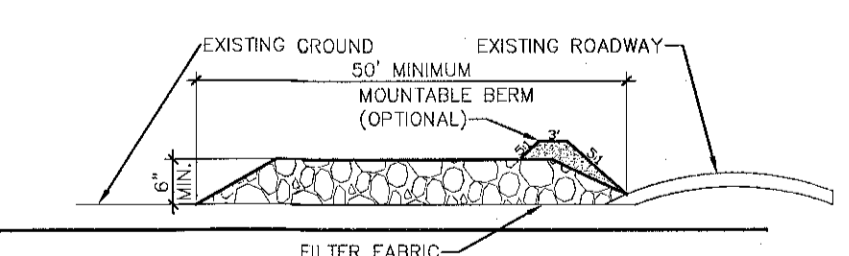


STABILIZED CONSTRUCTION ENTRANCE  
SCALE: NOT TO SCALE

CONSTRUCTION SPECIFICATIONS:  
1. STONE SIZE: USE 1\"/>

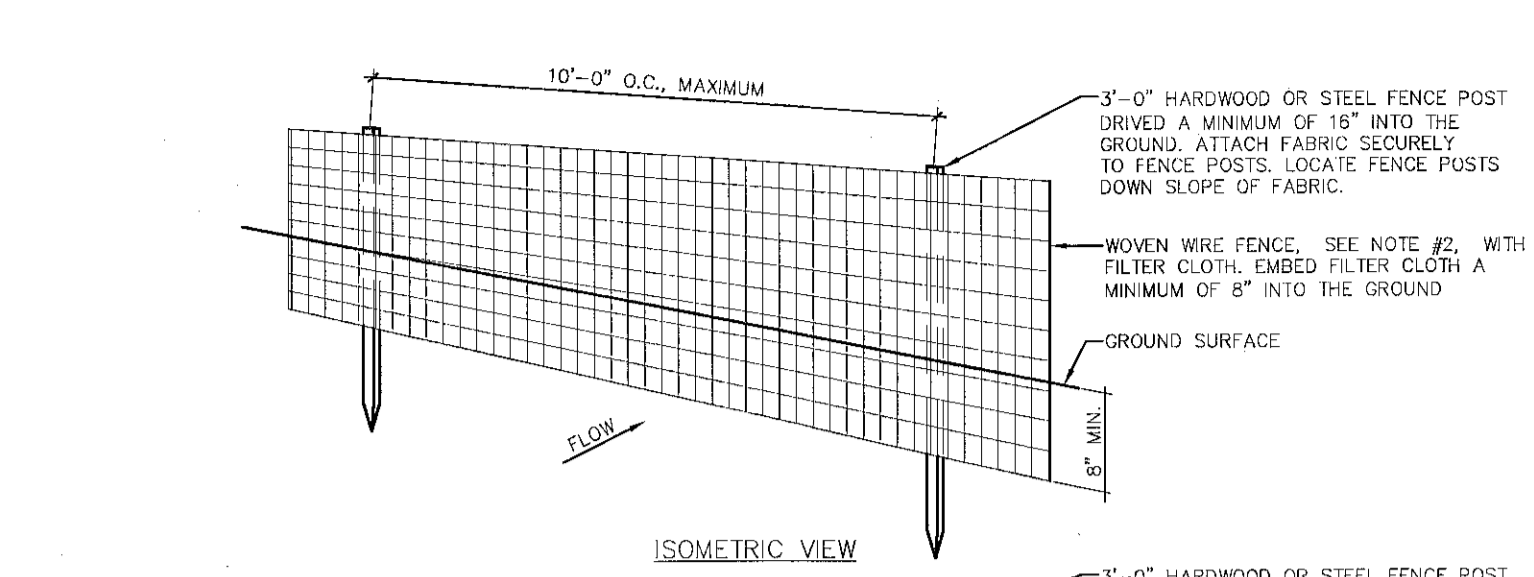


CONSTRUCTION SPECIFICATIONS:

1. WOVEN WIRE FENCE TO BE FASTENED SECURELY TO FENCE POSTS WITH WIRE TIES OR STAPLES. POSTS SHALL BE STEEL EITHER 1\"/>

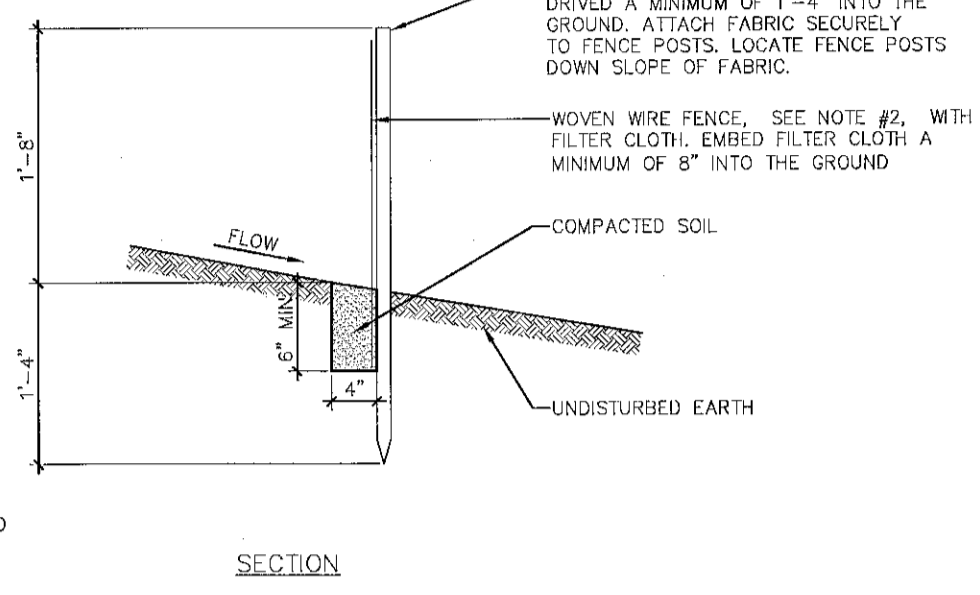


SEDIMENT CONTROL FENCE  
SCALE: NOT TO SCALE

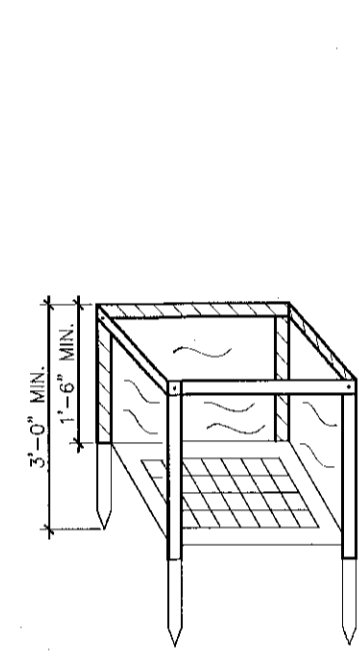


INLET PROTECTION  
SCALE: NOT TO SCALE


CONSTRUCTION SPECIFICATIONS:  
1. FILTER FABRIC SHALL HAVE AN EOS OF 40-85. BURLAP MAY BE USED FOR SHORT TERM APPLICATION.  
2. CUT FABRIC FROM A CONTINUOUS ROLL TO ELIMINATE JOINTS. IF JOINTS ARE NEEDED THEY WILL BE OVERLAPPED TO THE NEXT STAKE.  
3. STAKE MATERIALS WILL BE STANDARD 2\"/>

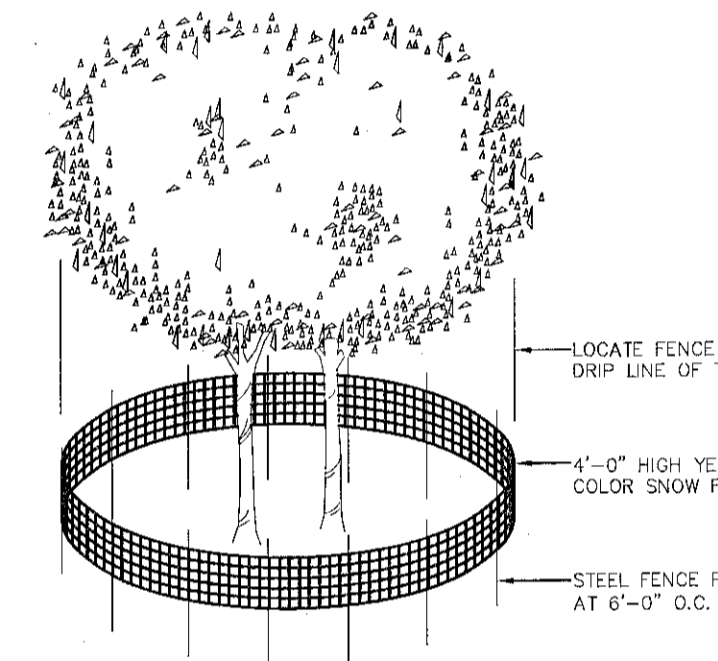

TREE PROTECTION FENCE  
SCALE: NOT TO SCALE

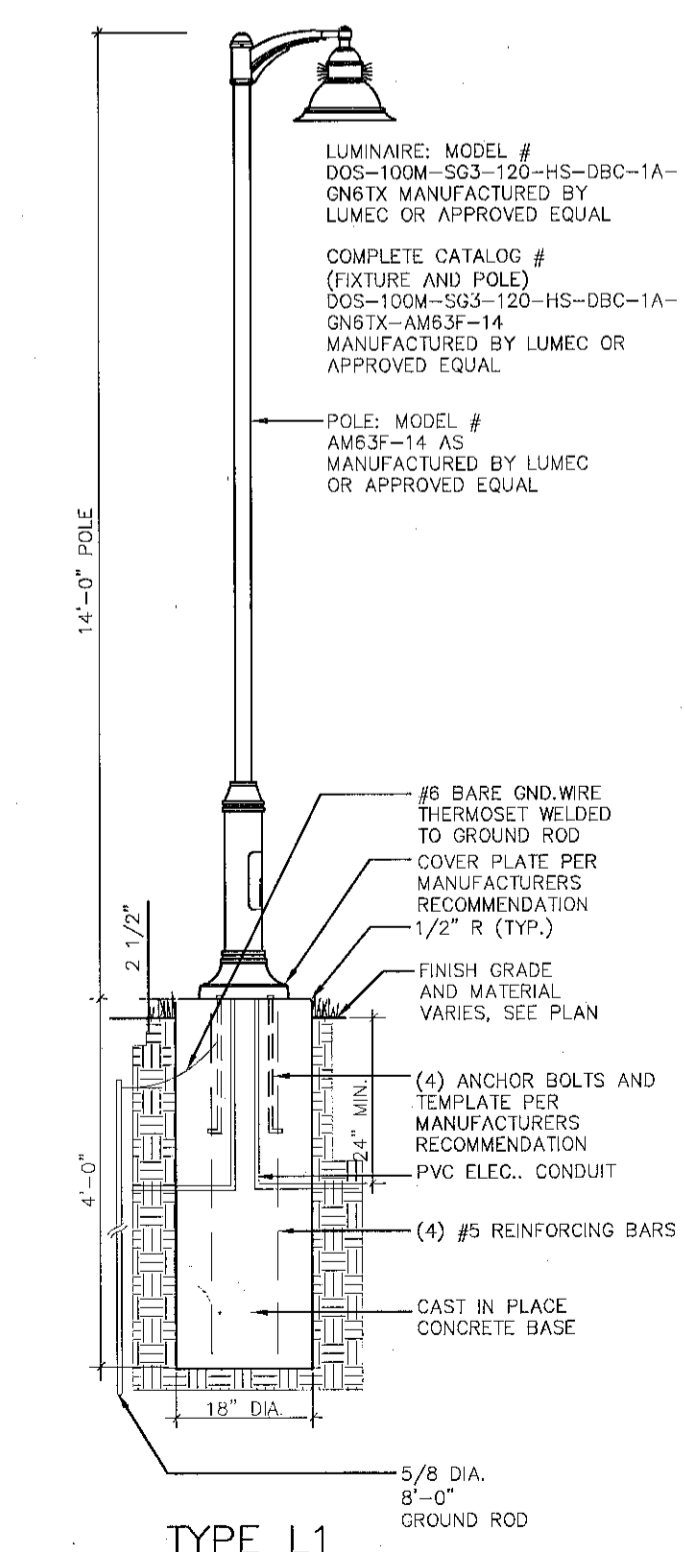

TYPE L1  
SITE LIGHTING  
SCALE: NOT TO SCALE

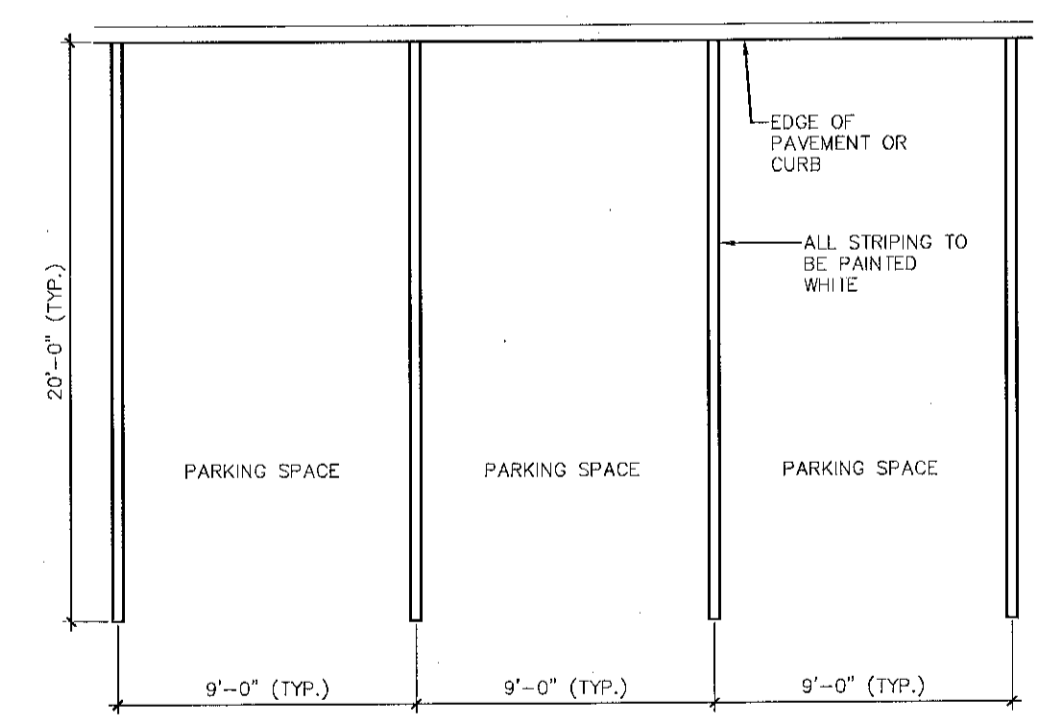


PAVEMENT STRIPING  
SCALE: NOT TO SCALE

RECEIVED  
APR 7 2011  
Town of Bethlehem  
Planning Board

PLANNING BOARD  
TOWN OF BETHLEHEM  
ALBANY COUNTY, NEW YORK  
This Site Plan Approved  
*George J. J...*  
Title Chairman  
Date 4/13/2011 SPA153A2

**infinigy**  
engineering  
11 Herbert Drive  
Latham, New York 12110  
(518) 690-0790

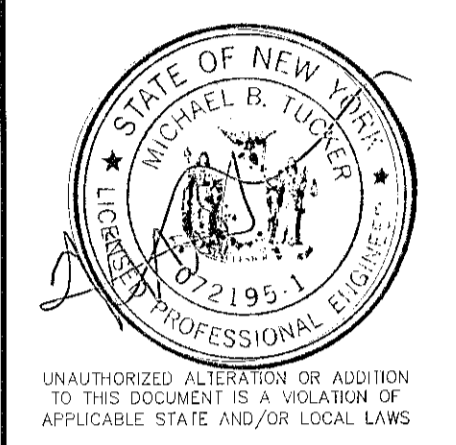

No.	Submital / Revision	Apprd	Date
4	TOWN COMMENTS	MBT	3/11
3	DESIGN COMMENTS	MBT	9/11/11
2	TOWN COMMENTS	MBT	12/10
1	TOWN COMMENTS	MBT	12/10

Drawn: M.B. Date: 10/10  
Designed: MBT Date: 10/10  
Checked: MBT Date: 10/10

Project Number  
182-122

Project Title

The Gables  
at Delmar  
Delaware Avenue  
Delmar, NY 12054

Prepared For  
**Keystone  
Builders Inc.**

Drawing Title  
**Site  
Details**

Drawing Scale:  
1" = 40'  
Date:  
01/20/2011

Issued For  
**SITE PLAN  
APPROVAL**

Drawing Number

**C-15**